



ZONING TABULATION		D COMMERCIAL I	DISTR	ZONE NC	F
	ORDINANCE	PROPOSED	VAR. REQ'D.	BUILDING AREA: IST - 6TH FLOOR:	
345-45 B(I) PERMITTED USE 345-45 B(2)	RETAIL, OFFICES	I COMMERCIAL UNITS	NO	FOOTPRINT = 5,113 SF LOT COVERAGE = 89.5%	Minervini Vandermar
345-45 B(9)	RESIDENTIAL ABOVE GROUND FLOOR	, 22 RESIDENTIAL UNITS	NO	* = PRE-EXISTING NON-CONFORMING LOT CONDITION	Architecture
345-45 D(2) LOT AREA (MIN.)	2,500 S.F.	5,711 S.F. 86'-9.5" <i>O</i> N NEWARK AVE	NO		Minervini Vandermark, LLC
345-45 D(3) LOT WIDTH (MIN.) 345-46 D(4) LOT DEPTH (MIN.)	25.00' 100.00'	19'-4" ON THIRD ST. VARIES	NO*	NOTE A - PARKING CALCULATION:	360 Fourteenth St. Hoboken,
345-45 D(5) FRONT YARD SETBACK	NONE	O'-O" ON NEWARK AVE. O'-O" ON THIRD ST.	NO	<u>DWELLING UNITS:</u> SHALL PROVIDE ON SITE, MIN. OF I.O SPACES PER UNIT = 22 SPACES <u>RETAIL SPACE:</u> SPACE PER 600 SF,	New Jersey, 07030 tel. 201-386-0637
345-45 D(6)SIDE YARD SETBACK MIN.345-45 D(7)REAR YARD SETBACK MIN.	NONE 15'-0" MIN.	0'-0" 15' PARALEL TO 3RD ST 21'9" PARALEL TO NEWARK AVE.	NO NO	EXCLUDING THE FIRST 5,000 SF OF GROUND AREA = 0 SPACES REQUIRED	fax 201-386-0628 www.mvarchitecture.com
345-45 D(8) BUILDING HEIGHT (MIN.) 345-45 D(9) BUILDING HEIGHT (MAX.)	3 STORIES 5 STORIES	- 6 STORIES, 70'-0"	YES	NOTE B - BICYCLE PARKING SPACES CALCULATION: RESIDENTIAL USE: SHALL PROVIDE ON SITE,	
345-45 D(9a) MIN. FLOOR TO CEILING HGT (ALL EXCEPT PARKING)		IST FLOOR COMMERCIAL: 20'-0" (FLR. TO FLR.) 2ND-6TH FLRS: 10'-0"	NO	MIN. OF 0.5 SPACES PER UNIT = II SPACES <u>RETAIL USE:</u> NOT REQUIRED ON SPACES LESS THAN 6,000 S.F. =4 SPACES PROVIDED	
345-45 D(9b) MAX. FLOOR TO CEILING HG (RESIDENTIAL ONLY)	12 -0	(FLR-TO-FLR) (9' CEILING)			Frank J. Minervini, AIA NJ License # 12576 NY License # 03 0297 63
345-45 E(2)OFF-STREET PARKING345-45 E(2c)PARKING SPACES		OFF-STREET PARKING NOT PROVIDED		NOTE C - ROOF APPURTENANCES COVERAGE CALCULATION:	
345-45 E(2g) PARKING SPACES 345-60 G(4) ROOF APPURTENANCES	22 (SEE NOTE A) 20% MAX (SEE NOTE C)	0 19.6%	<u>YES</u> NO	ROOF AREA = 3,052 SF ROOF COVERAGE = STAIR, ELEVATOR BULKHEADS, VESTIBULE & TOILET	
345-70 C BICYCLE PARKING (MIN.)	(SEE NOTE B)	I2 INT. + 4 EXT.	NO	=360 SF ROOF MOUNTED MECHANICALS = 110 SF TOTAL=600 SF	
				= <u>19.6%</u> LESS THAN 20%	Anthony C. Vandermark, Jr. AIA NJ License # 17698 NY License # 32710-1
R-1A ONE AND TWO FAMILY HOU R-1F ONE AND TWO FAMILY HOU R-2 MULTI-FAMILY ATTACHED F R-3 MULTI-FAMILY ATTACHED F R-4 MULTI-FAMILY MID-RISE R-4 MULTI-FAMILY HIGH-RISE H HISTORIC DISTRICTS OR OFFICE/RESIDENTIAL NC NEIGHBORHOOD COMMER C/A COMMERCIAL/AUTOMOTIVE HC HIGHWAY COMMERCIAL CBD CENTRAL BUSINESS DISTR U UNIVERSITY M MEDICAL G GOVERNMENT I INDUSTRIAL PI PORT INDUSTRIAL PI PORT INDUSTRIAL PI PORT INDUSTRIAL PI PORT INDUSTRIAL PI PORT INDUSTRIAL P/O PARKS/OPEN SPACE NJMC NEW JERSEY MEADOWLAN REDEVELOPMENT PLAN AREAS MISTORIC DISTRICTS HISTORIC DISTRICTS HISTORIC DISTRICTS HISTORIC DISTRICTS SUBDISTRICT A SUBDISTRICT A SUBDISTRICT A	JSING HOUSING (4 STO CIAL E LICT EVELOPMENT IDS COMMISSION el for full listing.	R-1		TY ZONING BOARD	A A - 07/06/17 ZONING SET VNA - 07/04/17 ZONING SET - 03/22/17 CLIENT REVIEW # Date Revision Project Number : 17-1351 Drawn by : MS Checked by : FJM, ACV Scale: : As noted Client RAYMOND ESHAGHOFF BSG MANAGEMENT COMPANY Address 285 NEWARK AVENUE BLOCK 11004, LOT 6 JERSEY CITY, NJ 07302 Project Description NEW 6 STORY, MIXED-USE BUILDING WITH A GROUND FLOOR COMMERCIAL UNIT, AND 22 RESIDENTIAL UNITS Sheet Title TITLE SHEET:
THE APPLICANT M ADDRESS AND/C COMPLY WITH TH COMMENTS OF TH JERSEY CITY REV AGENTS	R IE IE	CHAIRMAN		DATE	-KEY PLAN -VICINITY MAP DIAGRAM -ZONING TABULATION CHART Drawing No. 7–1
		ZO	NING	BOARD APPROVAL	


	R-1	ONE AND TWO FAMILY HOUSING
5	R-1A	ONE AND TWO FAMILY HOUSING
Ō	R-1F	ONE AND TWO FAMILY HOUSING
	R-2	MULTI-FAMILY ATTACHED HOUSING (4 S
	R-3	MULTI-FAMILY MID-RISE
	R-4	MULTI-FAMILY HIGH-RISE
	н	HISTORIC DISTRICTS
	OR	OFFICE/RESIDENTIAL
	NC	NEIGHBORHOOD COMMERCIAL
1	C/A	COMMERCIAL/AUTOMOTIVE
- C.	HC	HIGHWAY COMMERCIAL
- C.	CBD	CENTRAL BUSINESS DISTRICT
\$	U	UNIVERSITY
	М	MEDICAL
	G	GOVERNMENT
	I.	INDUSTRIAL
	PI	PORT INDUSTRIAL
	WPD	WATERFRONT PLANNED DEVELOPMENT
- ⁻ -	DT	DESTINATION TOURISM
	С	CEMETERY
	P/O	PARKS/OPEN SPACE
2	NJMC	NEW JERSEY MEADOWLANDS COMMISS
RE	DEVEL	OPMENT PLAN AREAS
4		right panel for full listing.
MAR	 ➢ HIST(□ REST □ PALIS ION WO ✓ SUBE 	Y DISTRICTS ORIC DISTRICTS AURANT OVERLAY ZONE SADE PRESERVATION OVERLAY RKS OFFICE/RESIDENTIAL DISTRICT A DISTRICT B
		[

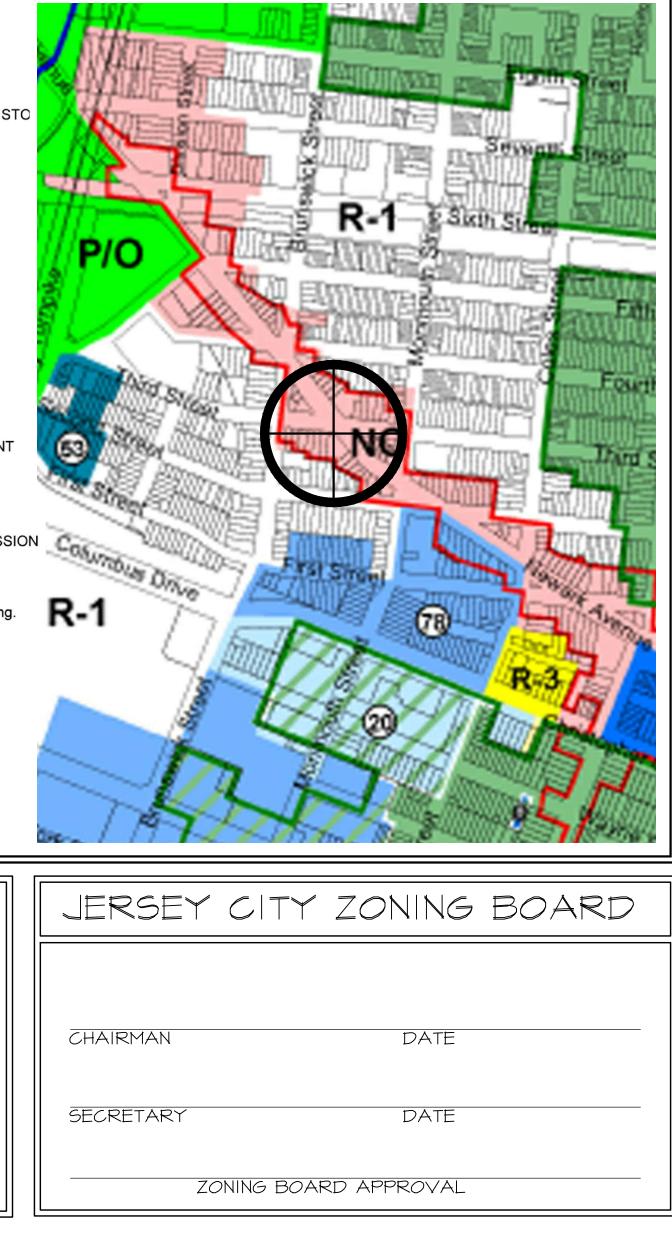


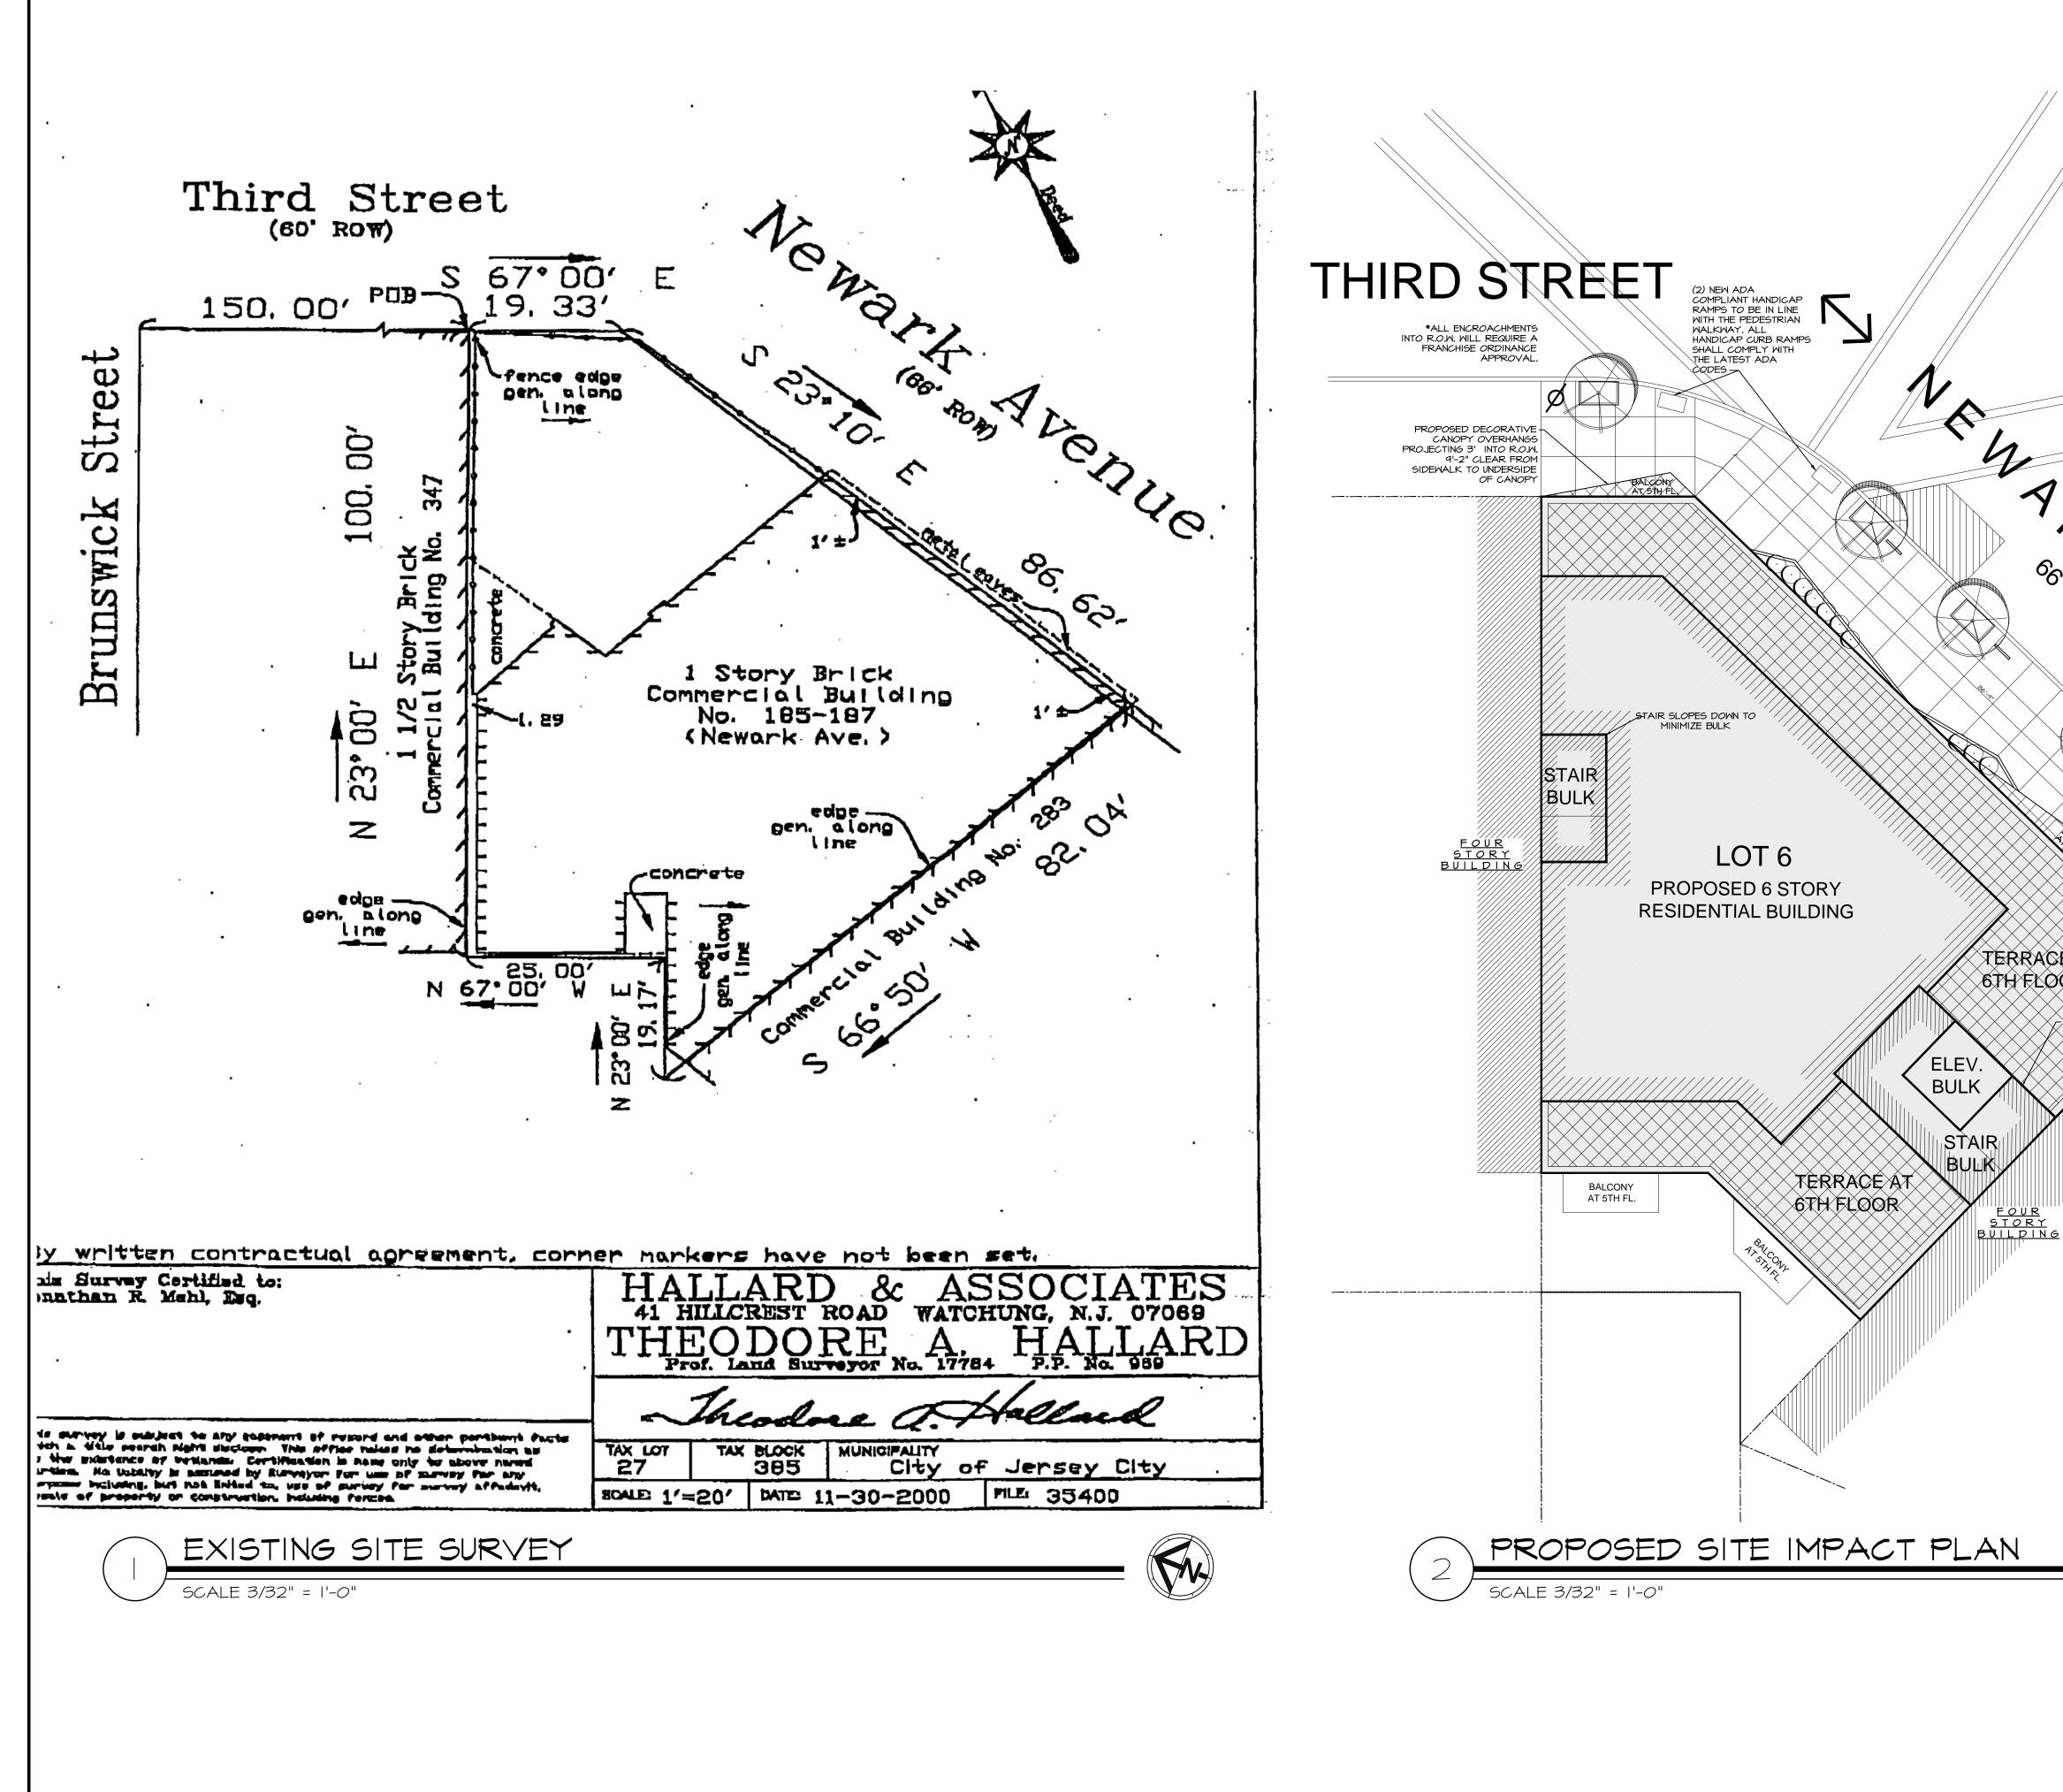

		Minervini Vandermar Architecture Minervini Vandermark, LLC Minervini Vandermark, LLC Sto Fourteenth St. Hoboken, New Jersey, 07030 tel. 201-386-0637 fax 201-386-0628 Www.mvarchitecture.com
A A A A A A A A A A A A A A	OR	Frank J. Minervini, AIA NJ License # 12576 NY License # 03 0297 63
E AT OR STAR SLOPPS DOWN 70 BULK	<text><text><text><text><text><text><text><text><text></text></text></text></text></text></text></text></text></text>	 O7/06/17 ZONING SET VNA O7/04/17 ZONING SET O3/22/17 CLIENT REVIEW # Date Revision Project Number : 17-1351 Drawn by : MS Checked by : FJM, ACV Scale: : As noted Client RAYMOND ESHAGHOFF BSG MANAGEMENT COMPANY Address 285 NEWARK AVENUE BLOCK 11004, LOT 6 JERSEY CITY, NJ 07302 Project Description NEW 6 STORY, MIXED-USE BUILDING WITH A GROUND FLOOR COMMERCIAL UNIT, AND 22 RESIDENTIAL UNITS Sheet Title EXISTING SITE SURVEY PROPOSED SITE
		IMPACT PLAN Drawing No.

Z-2

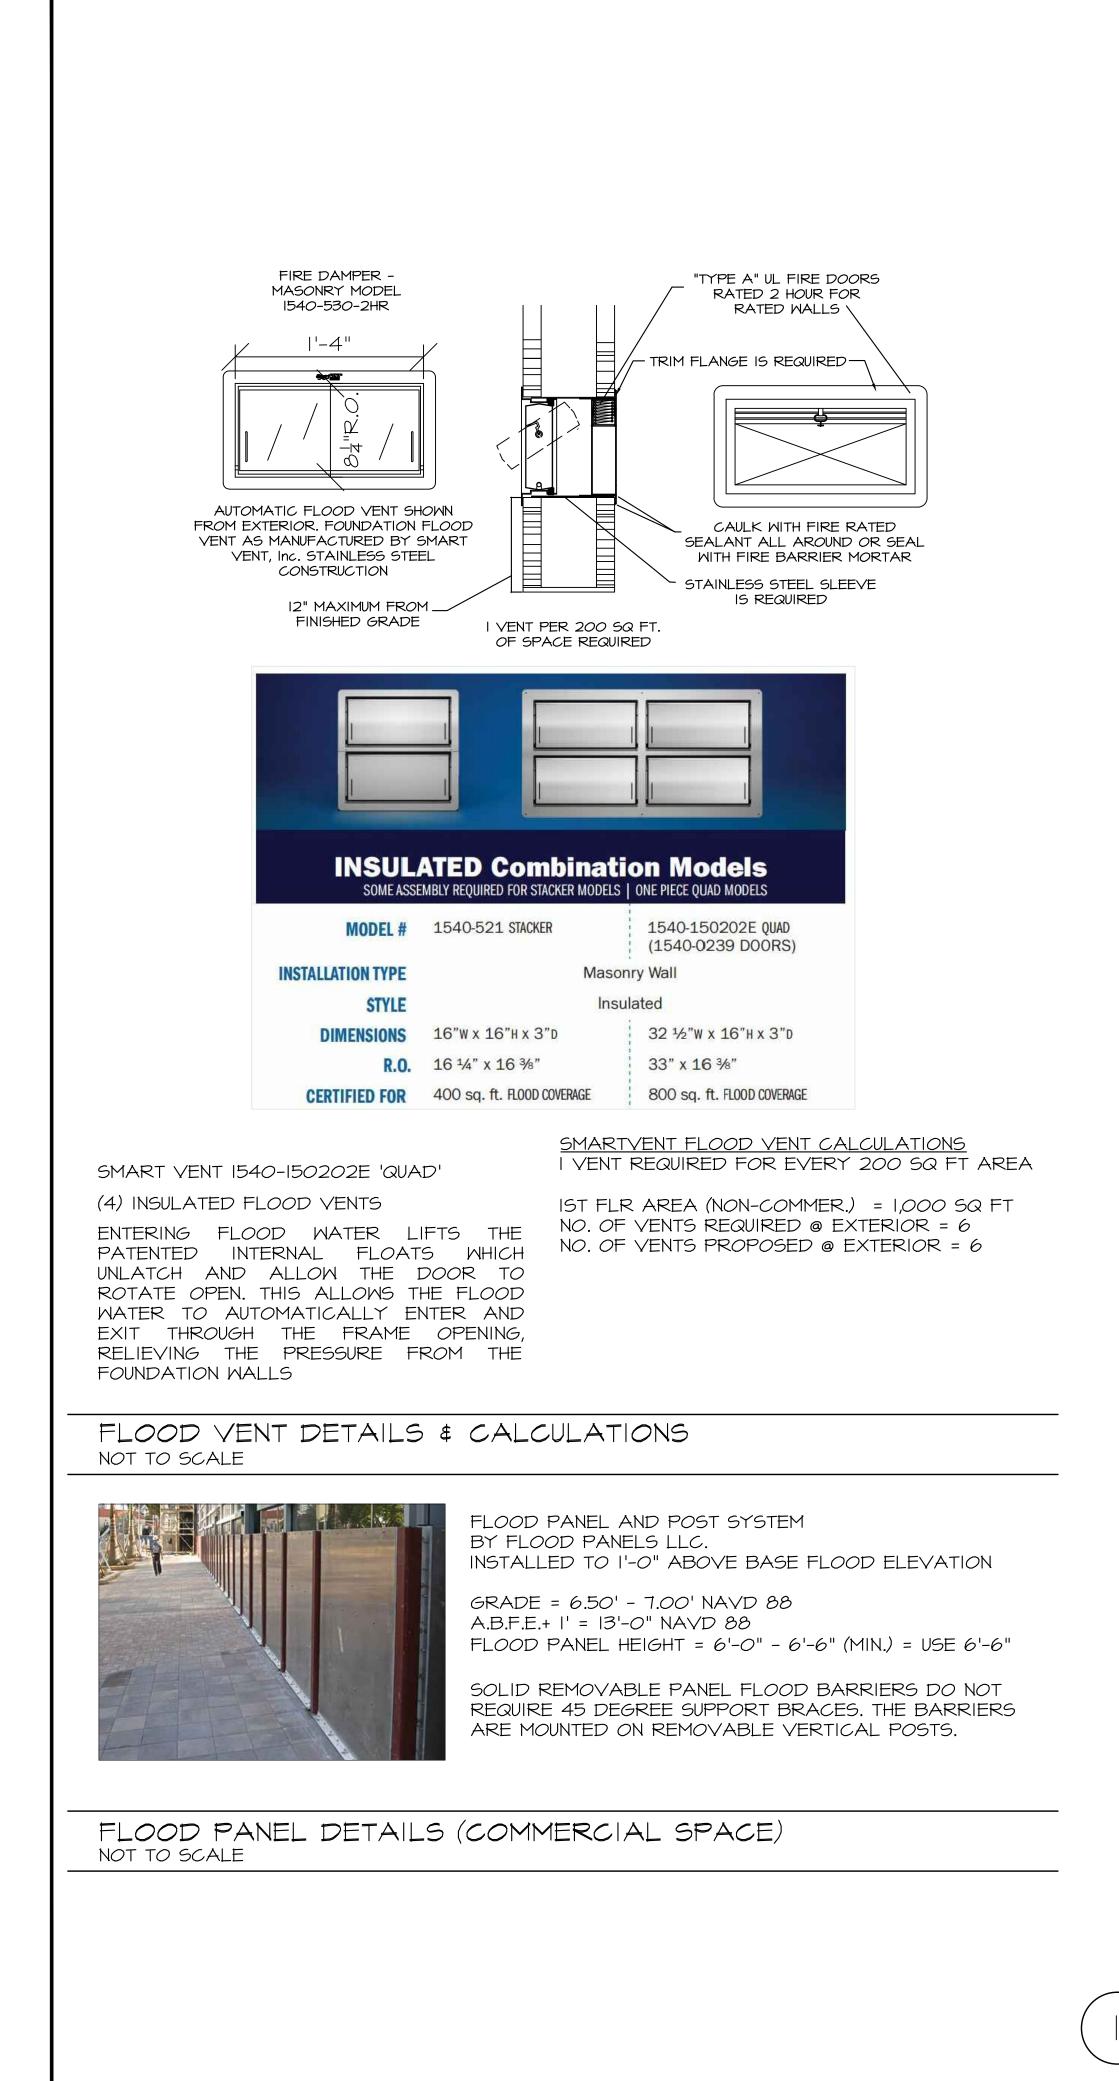

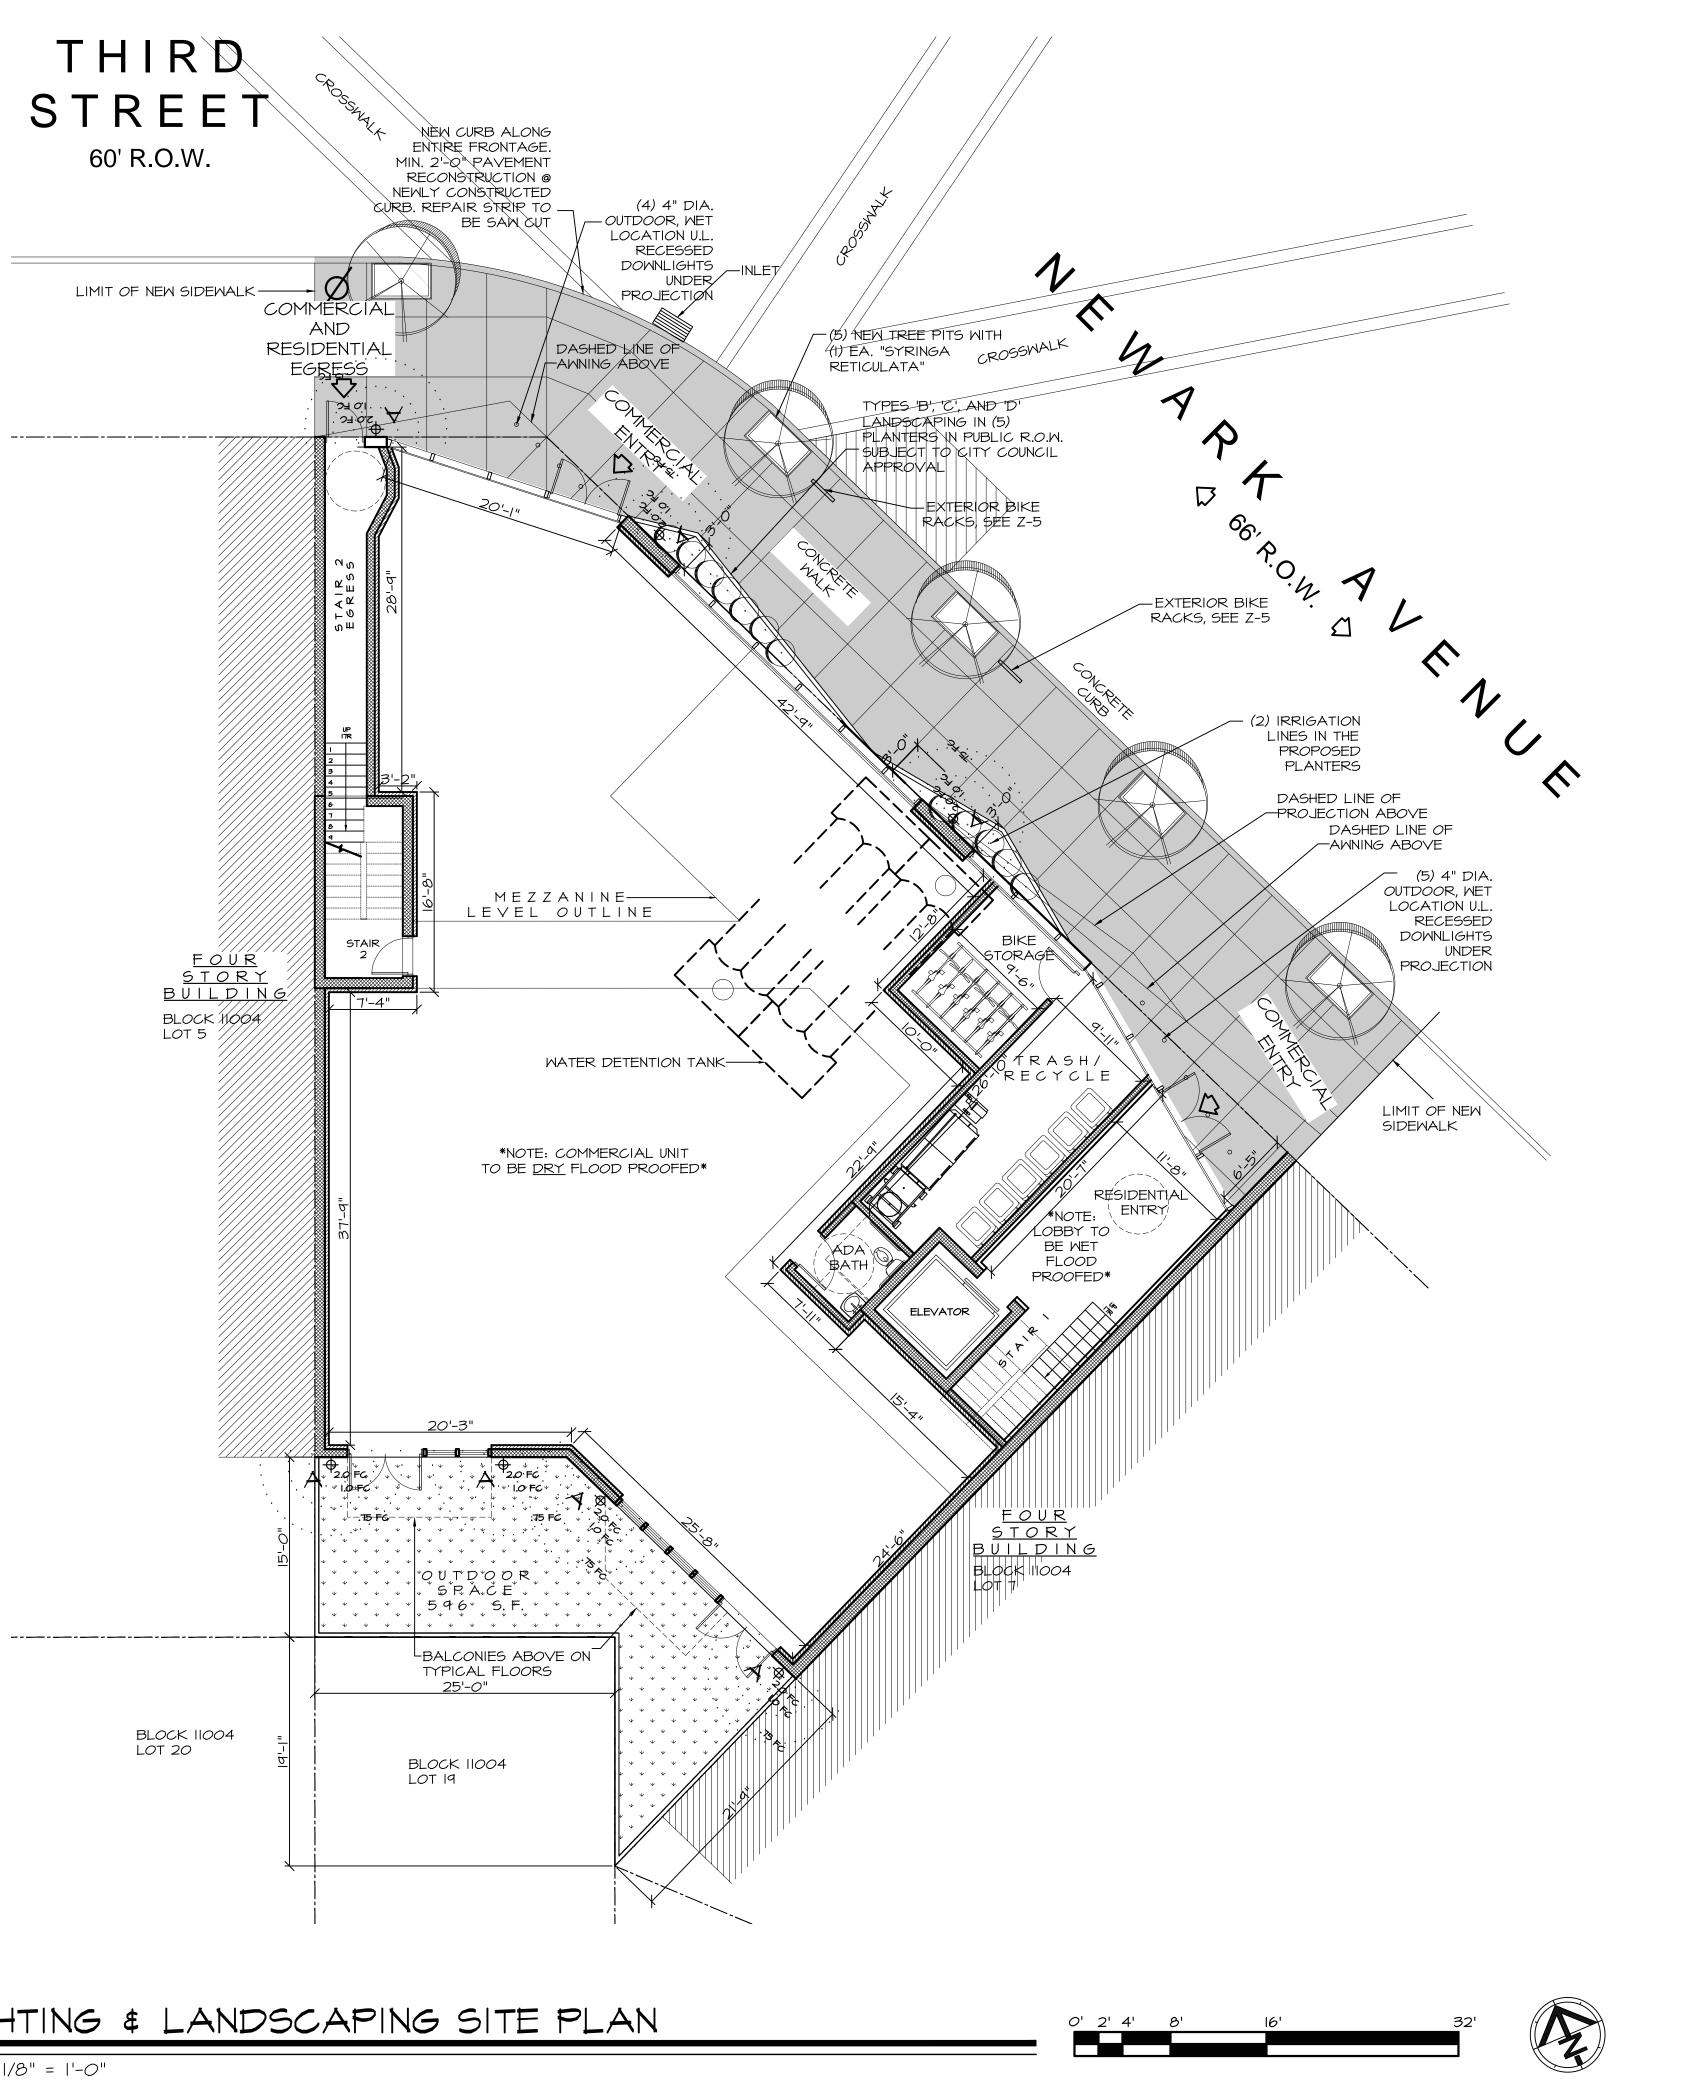

LIGHTING & LANDSCAPING SITE PLAN

SCALE 1/8" = 1'-0"

Minervini Vandermark Minervini Vandermark, LLC 360 Fourteenth St. Hoboken, New Jersey, 07030 fax 201-386-0637 www.mvarchitecture.com Frank J, Minervini, AIA NJ Jeense # 12576 Wilcense # 12576 Ny License # 32710-1 Incense # 17698 Ny Lic	FIRE
Hoboken, New Jersey, 07030 tel. 201-386-0628 WWW.mvarchitecture.com	Architecture
NULicense # 03 0297 63 Anthony C. Vandermark, Jr. AIA NULicense # 17698 NY License # 32710-1 Image: Stress # 32710-1 <tr< td=""><td>Hoboken, New Jersey, 07030 tel. 201-386-0637 fax 201-386-0628</td></tr<>	Hoboken, New Jersey, 07030 tel. 201-386-0637 fax 201-386-0628
NU License # 32710-1 Image: Construct of the system Image: Con	NJ License # 12576
- 07/04/17 ZONING SET - 03/22/17 CLIENT REVIEW # Date Revision Project Number : 17-1351 Drawn by : MS Checked by : FJM, ACV Scale: : As noted Client RAYMOND ESHAGHOFF BSG MANAGEMENT COMPANY Address 285 NEWARK AVENUE BLOCK 11004, LOT 6 JERSEY CITY, NJ 07302 Project Description NEW 6 STORY, MIXED-USE BUILDING WITH A GROUND FLOOR COMMERCIAL UNIT, AND 22 RESIDENTIAL UNITS Sheet Title LIGHTING & LANDSCAPING PLAN DETAILS	NJ License # 17698
- 07/04/17 ZONING SET - 03/22/17 CLIENT REVIEW # Date Revision Project Number : 17-1351 Drawn by : MS Checked by : FJM, ACV Scale: : As noted Client RAYMOND ESHAGHOFF BSG MANAGEMENT COMPANY Address 285 NEWARK AVENUE BLOCK 11004, LOT 6 JERSEY CITY, NJ 07302 Project Description NEW 6 STORY, MIXED-USE BUILDING WITH A GROUND FLOOR COMMERCIAL UNIT, AND 22 RESIDENTIAL UNITS Sheet Title LIGHTING & LANDSCAPING PLAN DETAILS	
Drawn by : MS Checked by : FJM, ACV Scale: : As noted Client RAYMOND ESHAGHOFF BSG MANAGEMENT COMPANY Address 285 NEWARK AVENUE BLOCK 11004, LOT 6 JERSEY CITY, NJ 07302 Project Description NEW 6 STORY, MIXED-USE BUILDING WITH A GROUND FLOOR COMMERCIAL UNIT, AND 22 RESIDENTIAL UNITS Sheet Title LIGHTING & LANDSCAPING PLAN DETAILS	- 07/04/17 ZONING SET - 03/22/17 CLIENT REVIEW
Address 285 NEWARK AVENUE BLOCK 11004, LOT 6 JERSEY CITY, NJ 07302 Project Description NEW 6 STORY, MIXED-USE BUILDING WITH A GROUND FLOOR COMMERCIAL UNIT, AND 22 RESIDENTIAL UNITS Sheet Title LIGHTING & LANDSCAPING PLAN DETAILS	Drawn by : MS Checked by : FJM, ACV Scale: : As noted Client
Project Description NEW 6 STORY, MIXED-USE BUILDING WITH A GROUND FLOOR COMMERCIAL UNIT, AND 22 RESIDENTIAL UNITS Sheet Title LIGHTING & LANDSCAPING PLAN DETAILS	Address 285 NEWARK AVENUE BLOCK 11004, LOT 6
LIGHTING & LANDSCAPING PLAN DETAILS	NEW 6 STORY, MIXED-USE BUILDING WITH A GROUND FLOOR COMMERCIAL UNIT, AND
Drawing No.	LIGHTING & LANDSCAPING PLAN
	Drawing No.

ALL FIRE SERVICE APPLICATIONS AND ALL DOMESTIC SERVICE APPLICATIONS TWO (2) INCHES AND LARGER MUST BE SUBMITTED TO THE JERSEY CITY MUNICIPAL UTILITIES AUTHORITY'S (JCMUA) BUREAU OF WATER ENGINEERING FOR APPROVAL

2. ALL EXISTING WATER SERVICE LINES TO BE ABANDONED SHALL BE CUT AND CAPPED AT THE MAIN, IN ACCORDANCE WITH JCMUA STANDARDS, AND INSPECTED WITHIN 24 HOURS AFTER INSTALLATION OF NEW TAP. THE MAXIMUM OF ONE (I) TAP SHALL BE MADE FOR BOTH DOMESTIC AND FIRE SERVICE PER FACILITY. THE TAP SHALL BE THE MAXIMUM OF ONE (I) SIZE SMALLER THAN THE CITY'S WATER MAIN. NO TAPPING SHALL BE DONE BY ANYONE EXCEPT BY UNITED WATER JERSEY CITY (UWJC) UNLESS SPECIFICALLY APPROVED BY JCMUA.

3. ONLY ONE DOMESTIC/FIRE SERVICE IS ALLOWED FOR EACH FACILITY. APPLICANT MAY INSTALL CHECK METERS ON INDIVIDUAL BRANCH CONNECTIONS DOWNSTREAM OF DOMESTIC METER SETUP WHERE THERE IS MORE THAN ONE OWNER/TENANT FOR A FACILITY HOWEVER, ONLY ONE WATER BILL WILL BE ISSUED.

4. A SOLID IRON TAPPING SLEEVE SUCH AS MUELLER H-615 TAPPING SLEEVE OR APPROVED EQUAL SHALL BE UTILIZED FOR ALL TAPS 2-INCHES AND LARGER. THE TAPPING SLEEVE SHALL PASS PRESSURE TESTING BASED ON AWWA STANDARDS BEFORE TAP IS MADE.

5. FOR ALL SERVICES INCLUDED HEREIN, TWO (2) GATE VALVES ARE REQUIRED THAT ARE TO BE INSTALLED BY THE APPLICANT; A TAPPING VALVE, LOCATED AT THE TAP AND CURB VALVE, LOCATED IN THE SIDEWALK BEFORE THE METER. TAPPING GATES SHALL BE FURNISHED OPENED RIGHT. ALL TAPPING AND CURB VALVES SHALL BE DOUBLE DISC GATE VALVES AND MEET AWWA STANDARDS. THE WET TAP UP TO 12 INCHES SHALL BE PERFORMED BY UWJC.

6. FOR TAPS OFF MAIN SIXTEEN (16) INCHES AND LARGER, THE APPLICANT SHALL FURNISH AND INSTALL AN ADDITIONAL GATE VALVE ADJACENT TO THE TAPPING VALVE. NO TAPS SHALL BE PERMITTED ON MAINS LARGER THAN TWENTY (20) INCHES UNLESS THERE IS NO ALTERNATIVE WATER SOURCE, AND SPECIAL WRITTEN APPROVAL IS ISSUED BY THE JCMUA.

7. VALVE BOX PARTS FOR ALL VALVES SHALL BE PROVIDED BY THE APPLICANT. ALL TAPPING GATE VALVES LARGER THAN 2-INCHES AND ALL CURB VALVES / STOPS REGARDLESS OF SIZE REQUIRE A VALVE BOX WITH THE WORD "WATER" CAST IN THE COVER. BURIED CORPORATION VALVES / STOPS SHALL BE USED AT THE TAP FOR CLASS K COPPER SERVICES 2-INCHES AND SMALLER.

8. ALL SERVICE PIPES, SIZES 2-INCHES THROUGH 12-INCHES, SHALL BE PRESSURE CLASS 350 PSI, CEMENT-LINED DUCTILE IRON PIPE WITH MECHANICAL JOINTS.

9. THE APPLICANT SHALL INSTALL THE METER INSIDE THE BUILDING. IF THE BUILDING LINE IS IN EXCESS OF 75 FT. FROM THE MAIN, THE APPLICANT SHALL PLACE THE METER IN A PIT NEAR THE SIDEWALK OR STREET IN CLOSE PROXIMITY TO THE TAP.

IO. FOR A REGULAR FIRE SUPPRESSION SYSTEM (COMBINED SERVICE LINE LARGER THAN 2"), A COMBINED REDUCED PRESSURE DETECTOR ASSEMBLY (AMES 5000 SS, AMES 5000 RPDA OR WATTS 909 RPDA) SHALL BE INSTALLED ON THE MAIN FIRE SERVICE AND A REDUCED PRESSURE BACKFLOW PREVENTER ON THE BYPASS (AMES 4000 SS OR WATTS 909). ON THE LIMITED FIRE SUPPRESSION SYSTEM (COMBINED SERVICE LINE 1.5" OR 2"), A FIRE LINE DETECTOR CHECK WITH A SINGLE CHECK VALVE (AMES 1000 DCV) SHALL BE INSTALLED ON THE MAIN FIRE LINE AND A REDUCED PRESSURE BACKFLOW PREVENTER (AMES 4000 SS OR WATTS 909) SHALL BE INSTALLED DOWNSTREAM OF THE BYPASS. ALL REGULAR FIRE SUPPRESSION SYSTEMS MUST HAVE OS&Y VALVES, HOWEVER, LIMITED FIRE SUPPRESSION SYSTEMS MAY USE BALL VALVES (VICTAULIC SERIES 728 FIRELOCK) INSTEAD OF OS&Y VALVES. THE FIRE UNIT SHALL BE FURNISHED WITH A 5/8 INCH X 3/4 INCH METERED BYPASS. BYPASS METERS SHALL BE JERSEY CITY STANDARD SINGLE DISPLACEMENT SENSUS METERS WITH TOUCH PAD AND RADIO READ CAPABILITIES. THE SAME RADIO MXU UNIT SHALL BE USED FOR A COMBINED DOMESTIC AND FIRE SERVICE.

FOR DOMESTIC SERVICE, AN APPROVED REDUCED PRESSURE BACKFLOW PREVENTER (AMES 4000 SS OR WATTS 909) IS REQUIRED WHEN THE JCMUA DETERMINES THAT THERE IS A CROSS-CONNECTION HAZARD AND THE FACILITY PRESENTS A THREAT TO THE CITY'S DISTRIBUTION SYSTEM WATER QUALITY IN ACCORDANCE WITH THE PLUMBING SUBCODE OF THE NEW JERSEY UNIFORM CONSTRUCTION CODE, NJAC 5:23-3.15 AND THE NEW JERSEY SAFE DRINKING WATER ACT NJAC 7:10-10 PHYSICAL CONNECTIONS AND CROSS CONNECTIONS CONTROL BY CONTAINMENT. SOME SERVICES WHICH REQUIRE SUCH DEVICES INCLUDE: A HOSPITAL, SCHOOL, CHEMICAL PLANT FACTORY, AND A FACILITY WITH SEWAGE EJECTORS.

12. IF A REDUCED PRESSURE BACKFLOW PREVENTER IS NOT REQUIRED ON THE DOMESTIC SERVICE, A CHECK VALVE SHOULD BE INSTALLED DOWNSTREAM OF THE TEST TEE.

13. ALL METERS SIZES 2 INCHES THROUGH 6 INCHES SHALL BE SINGLE COMPOUND METERS AND ALL METERS & INCHES AND LARGER SHALL BE DUPLEX COMPOUND MANIFOLD METERS.

14. ALL METERS SHALL BE ADEQUATELY RESTRAINED WITH METAL BRACKETS FASTENED TO THE FLOOR OR WALL OR OTHER APPROVED MEANS SUCH AS UNIFLANGES WHERE INTERNAL PIPE PRESSURE AND FLOW WARRANT SUCH RESTRAINTS. METERS, DETECTOR CHECKS, AND VALVES MAY BE SEATED ON CONCRETE BLOCK AND TAPERED SHIMS TO PROVIDE ADEQUATE SUPPORT. METERS SHALL BE INSTALLED APPROXIMATELY 36" ABOVE FLOOR GRADE.

15. ALL METER INSTALLATIONS IN METER PIT OR VAULT SHALL BE PRE-APPROVED BY JCMUA AND HAVE PROPER ACCESS OPENINGS FOR METER READING AND REPLACEMENT.

16. EACH COMPOUND METER SHALL HAVE STRAINER INSTALLED ON THE INLET SIDE IMMEDIATELY BEFORE THE METER. ALL STRAINERS MUST BE PURCHASED FROM JCMUA OR IT'S AUTHORIZED AGENT.

17. ALL METERS 2" AND LARGER SHALL BE FURNISHED WITH SENSUS ECR/WP REMOTE TOUCH PAD MODULES AND RADIO MXU UNITS FOR BOTH TYPES OF READING CAPABILITIES.

18. REMOTE TOUCH PAD MODULE WIRE SHALL BE CONNECTED TO THE METER REGISTER UTILIZING A GEL CAP FOR WATERTIGHT SEALING OF ALL TERMINAL CONNECTIONS. TOUCH PADS MAY BE WALL MOUNTED OR LID MOUNTED WHERE A METER PIT IS UTILIZED. TOUCH PADS ARE TO BE INSTALLED ON EXTERIOR BUILDING WALL FACING THE STREET AND LOCATED AS CLOSE AS POSSIBLE TO STREET. THE RADIO MXU UNIT MUST BE INSTALLED WITH MOUNTING BRACKETS AND LIKEWISE IS TO BE INSTALLED IN PROXIMITY TO THE STREET.

19. ALL INSTALLATIONS OF EQUIPMENT AND COMPONENTS SHALL BE PERFORMED IN ACCORDANCE MITH MANUFACTURER'S RECOMMENDATIONS.

20. ALL METERS INCLUDING TOUCH PAD MODULES, AND RADIO MXU UNITS SHALL BE PURCHASED THROUGH THE PERMIT CLERK AT JCMUA OFFICE. APPROVED PLANS MUST BE SUBMITTED TO THE PERMIT CLERK FOR ISSUANCE OF REQUIRED PERMITS.

21. AFTER OBTAINING THE REQUIRED PERMITS (STREET OPENING, TAP AND METER) THE APPLICANT SHALL CALL UNJC AT (201 239-1108 TO SCHEDULE THE TAP. THE EXCAVATION SHALL BE COMPLETED TWENTY-FOUR (24) HOURS PRIOR TO THE SCHEDULED TAP AND VERIFIED BY JCMUA OR ITS AUTHORIZED AGENT BEFORE THE TAP WILL BE INSTALLED. EXCAVATION SHALL BE CONSTRUCTED IN ACCORDANCE WITH OSHA REQUIREMENTS FOR SHEETING AND SAFETY.

22. UPON COMPLETION OF THE INSTALLATION, THE APPLICANT SHALL SUBMIT THREE (3) SETS OF "AS BUILT" PLANS, TO THE JCMUA'S BUREAU OF WATER ENGINEERING. THE JCMUA WILL AUTHORIZE SUPPLY WATER UPON ACCEPTANCE OF THE "AS BUILT" DRAWINGS.

BEDDING AND BACKFILL MATERIAL SHALL COMPLY WITH THE REQUIREMENTS OF THE NJDOT'S STANDARD SPECIFICATION FOR ROAD AND BRIDGE CONSTRUCTION, AND THE DESIGN AND CONSTRUCTION OF URBAN STORMWATER MANAGEMENT SYSTEMS, ASCE MANUALS AND REPORTS OF ENGINEERING PRACTICE NO. 77, 1993, AS APPLICABLE.

2. ALL SEWER SERVICE CONNECTIONS 6-INCHES IN SIZE OR SMALLER MUST BE MADE DIRECTLY TO THE SEWER MAIN AND ALL CONNECTIONS 8-INCHES IN SIZE OR LARGER MUST BE MADE TO A MANHOLE. WHERE A CONNECTION TO A MANHOLE IS REQUIRED, MANHOLE BENCH AND CHANNEL MAY REQUIRE MODIFICATION.

THE JCMUA REQUIRES THAT SEWER SERVICE CONNECTIONS TO BE RE-USED BE TELEVISED TO VERIFY THEIR INTEGRITY AND THAT THE PIPE IS FREE FROM ANY DEFECTS.

EACH BUILDING CONNECTION REQUIRES A CURB CLEANOUT (REFER TO ATTACHED DETAIL DRAWINGS). T-WYE CLEANOUTS WHICH ENABLE CLEANING IN BOTH DIRECTIONS SHOULD BE INSTALLED ON BOTH THE STORM AND SANITARY LATERAL

PROPOSED SEWER LATERAL CONNECTION TO JCMUA'S SEWER MAIN SHALL BE MADE ABOVE HORIZONTAL CENTER LINE OF PIPE (REFER TO ATTACHED SEWER SERVICE CONNECTION DETAILS).

6. THE SIZE, MATERIAL, DEPTH, CONDITION, DIRECTION OF FLOW AND ANY OTHER RELEVANT CONDITIONS OF THE EXISTING JCMUA SEWER TO WHICH YOU PLAN TO CONNECT MUST BE FIELD VERIFIED BY DEVELOPER TO DETERMINE IF SAID CONNECTION IS PHYSICALLY POSSIBLE AND PRACTICAL. IN ADDITION, MANHOLE INVERTS AND RIM ELEVATION MUST BE SHOWN ON PLANS. THIS VERIFICATION IS TO BE INCLUDED ON THE PLANS FOR THE PROJECT.

CIRCULAR HOLE SAWS WHICH ARE APPROXIMATELY SIZED OR HAND DRILLED MUST BE USED TO MAKE OPENINGS IN THE EXISTING SEWER TO RECEIVE THE LATERALS. JACKHAMMERS SLEDGEHAMMERS AND OTHER UNSUITABLE TOOLS OR MACHINERY WHICH MAY DAMAGE THE JCMUA'S SEWER MAIN ARE NOT ALLOWED TO BE USED TO MAKE THE LATERAL OPENINGS. ALL DEBRIS MUST BE REMOVED AND NOT ALLOWED TO FALL INTO PIPE.

8. A DETAIL OF ANY PROPOSED MANHOLE OR CATCH BASIN SHOWING ALL DIMENSIONS IN ADDITION TO RIM, GRATE AND INVERT ELEVATIONS OF THE STRUCTURE AND ALL PIPES CONNECTED TO THE STRUCTURE MUST BE SHOWN ON PLANS.

PROPOSED MANHOLES CONSTRUCTED IN THE PUBLIC R.O.W. а ON EXISTING OR PROPOSED JCMUA SEWERS SHALL BE FURNISHED WITH CONCENTRIC MANHOLE COVERS AS MANUFACTURED BY CAMPBELL FOUNDRY CO., PATTERN #4428 OR EQUAL WITH OUTSIDE COVER DIAMETER OF 31-3/4 INCHES AND INSIDE COVER DIAMETER OF 24 INCHES.

THE LETTERS "JCMUA" AND "SEWER" SHALL BE CAST IN THE INSIDE COVER. MANHOLE FRAMES SHALL BE CAMPBELL FOUNDRY CO. PATTERN #4428 (FOR 30-INCH OPENING) OR #1206 (FOR 41-INCH OPENING) OR EQUAL FURNISHED WITH A PATER #4428 CONCENTRIC COVER AS SPECIFIED IN THE PRECEDING PARAGRAPH. REFER TO JCMUA'S STANDARD DETAIL FOR MANHOLE FRAME AND COVERS.

IO. STORM INLETS WHICH ARE CONNECTED DIRECTLY TO JCMUA COMBINED SEWER MUST BE FURNISHED WITH A SUMP AND TRAP AS PER JCMUA STANDARD DETAILS.

II. THE JCMUA HAS A COMBINED SEWER SYSTEM WHICH SURCHARGES DURING WET WEATHER PERIODS RESULTING IN POSSIBLE SEWAGE BACK-UPS THROUGH PLUMBING FIXTURES (SINKS, TOILETS, FLOOR DRAINS, ETC) BELOW STREET LEVEL. THIS POSSIBILITY MUST BE ADDRESSED DURING THE DESIGN/CONSTRUCTION PHASE.

II. A DROP MANHOLE CONNECTION SHALL BE USED WHERE THERE IS A DIFFERENCE IN ELEVATION OF TWO (2) FEET OR GREATER BETWEEN THE INVERT OF A SANITARY OR COMBINED INLET PIPE TO MANHOLE AND THE CROWN OF THE OUTLET PIPE FROM MANHOLE. REFER TO ATTACHED JCMUA'S STANDARD DETAIL FOR DROP MANHOLE CONNECTION WHICH MUST BE SHOWN ON SITE PLAN IF REQUIRED.

12. TEST PITS MUST BE PERFORMED AT THE DEVELOPER'S EXPENSE DURING THE DESIGN PHASE OF THE PROJECT TO ENSURE THAT PROPOSED SEWERS AND SEWER SERVICES MAY BE CONSTRUCTED AS PROPOSED WITHOUT CONFLICTING WITH OTHER UNDERGROUND UTILITIES OR STRUCTURES.

13. ALL EXISTING SEWER MAINS AND SANITARY LATERALS TO BE ABANDONED MUST BE FILLED WITH CONCRETE SLURRY OR REMOVED FROM THE GROUND. CATCH BASINS AND MANHOLES MUST BE REMOVED FROM THE GROUND. CONNECTIONS MUST BE CUT AND SEALED AT THE MAIN AND PRECAUTIONS MUST BE UNDERTAKEN BY THE CONTRACTOR TO ENSURE CONCRETE AND OTHER MATERIALS DO NOT ENTER THE MAIN AND CREATE OBSTRUCTION(S).

14. ALL PROPOSED INLET/CATCH BASINS MUST BE CONSTRUCTED WITH A BICYCLE SAFE GRATE AND CAMPBELL FOUNDRY CO. TYPE 'N' CURBPIECE WHERE REQUIRED. 15. PROPOSED WATER SERVICES REQUIRE THE REVIEW AND

16. THE CONTRACTOR IS RESPONSIBLE FOR OBTAINING PERMITS FOR STREET OPENINGS FROM THE JERSEY CITY BUILDING DEPARTMENT LOCATED AT 30 MONTGOMERY STREET, JERSEY CITY, NJ AND ALL OTHER APPLICABLE PERMITS FROM AGENCIES HAVING JURISDICTION.


THE SYSTEM DESIGNER IS ALSO RESPONSIBLE FOR COMPLIANCE WITH THE APPLICABLE REGULATIONS OF THE NEW JERSEY ADMINISTRATIVE CODE, NJDEP RULES AND REGULATIONS GOVERNING TREATMENT WORKS APPORVAL PROGRAM, LOCAL CODES AND ORDINANCES, FEDERAL AND STATE REGULATIONS ETC. IN ADDITION TO OTHER REQUIREMENTS THAT MAY BE IMPOSED BY THE JCMUA.




JCMUA REQUIREMENTS FOR FIRE \$ DOMESTIC WATER LINE & METER INSTALLATION


APPROVAL OF THE DIVISION OF WATER ENGINEERING.


JCMUA REQUIREMENTS FOR NEW SANITARY & STORM SEWERS AND SERVICE

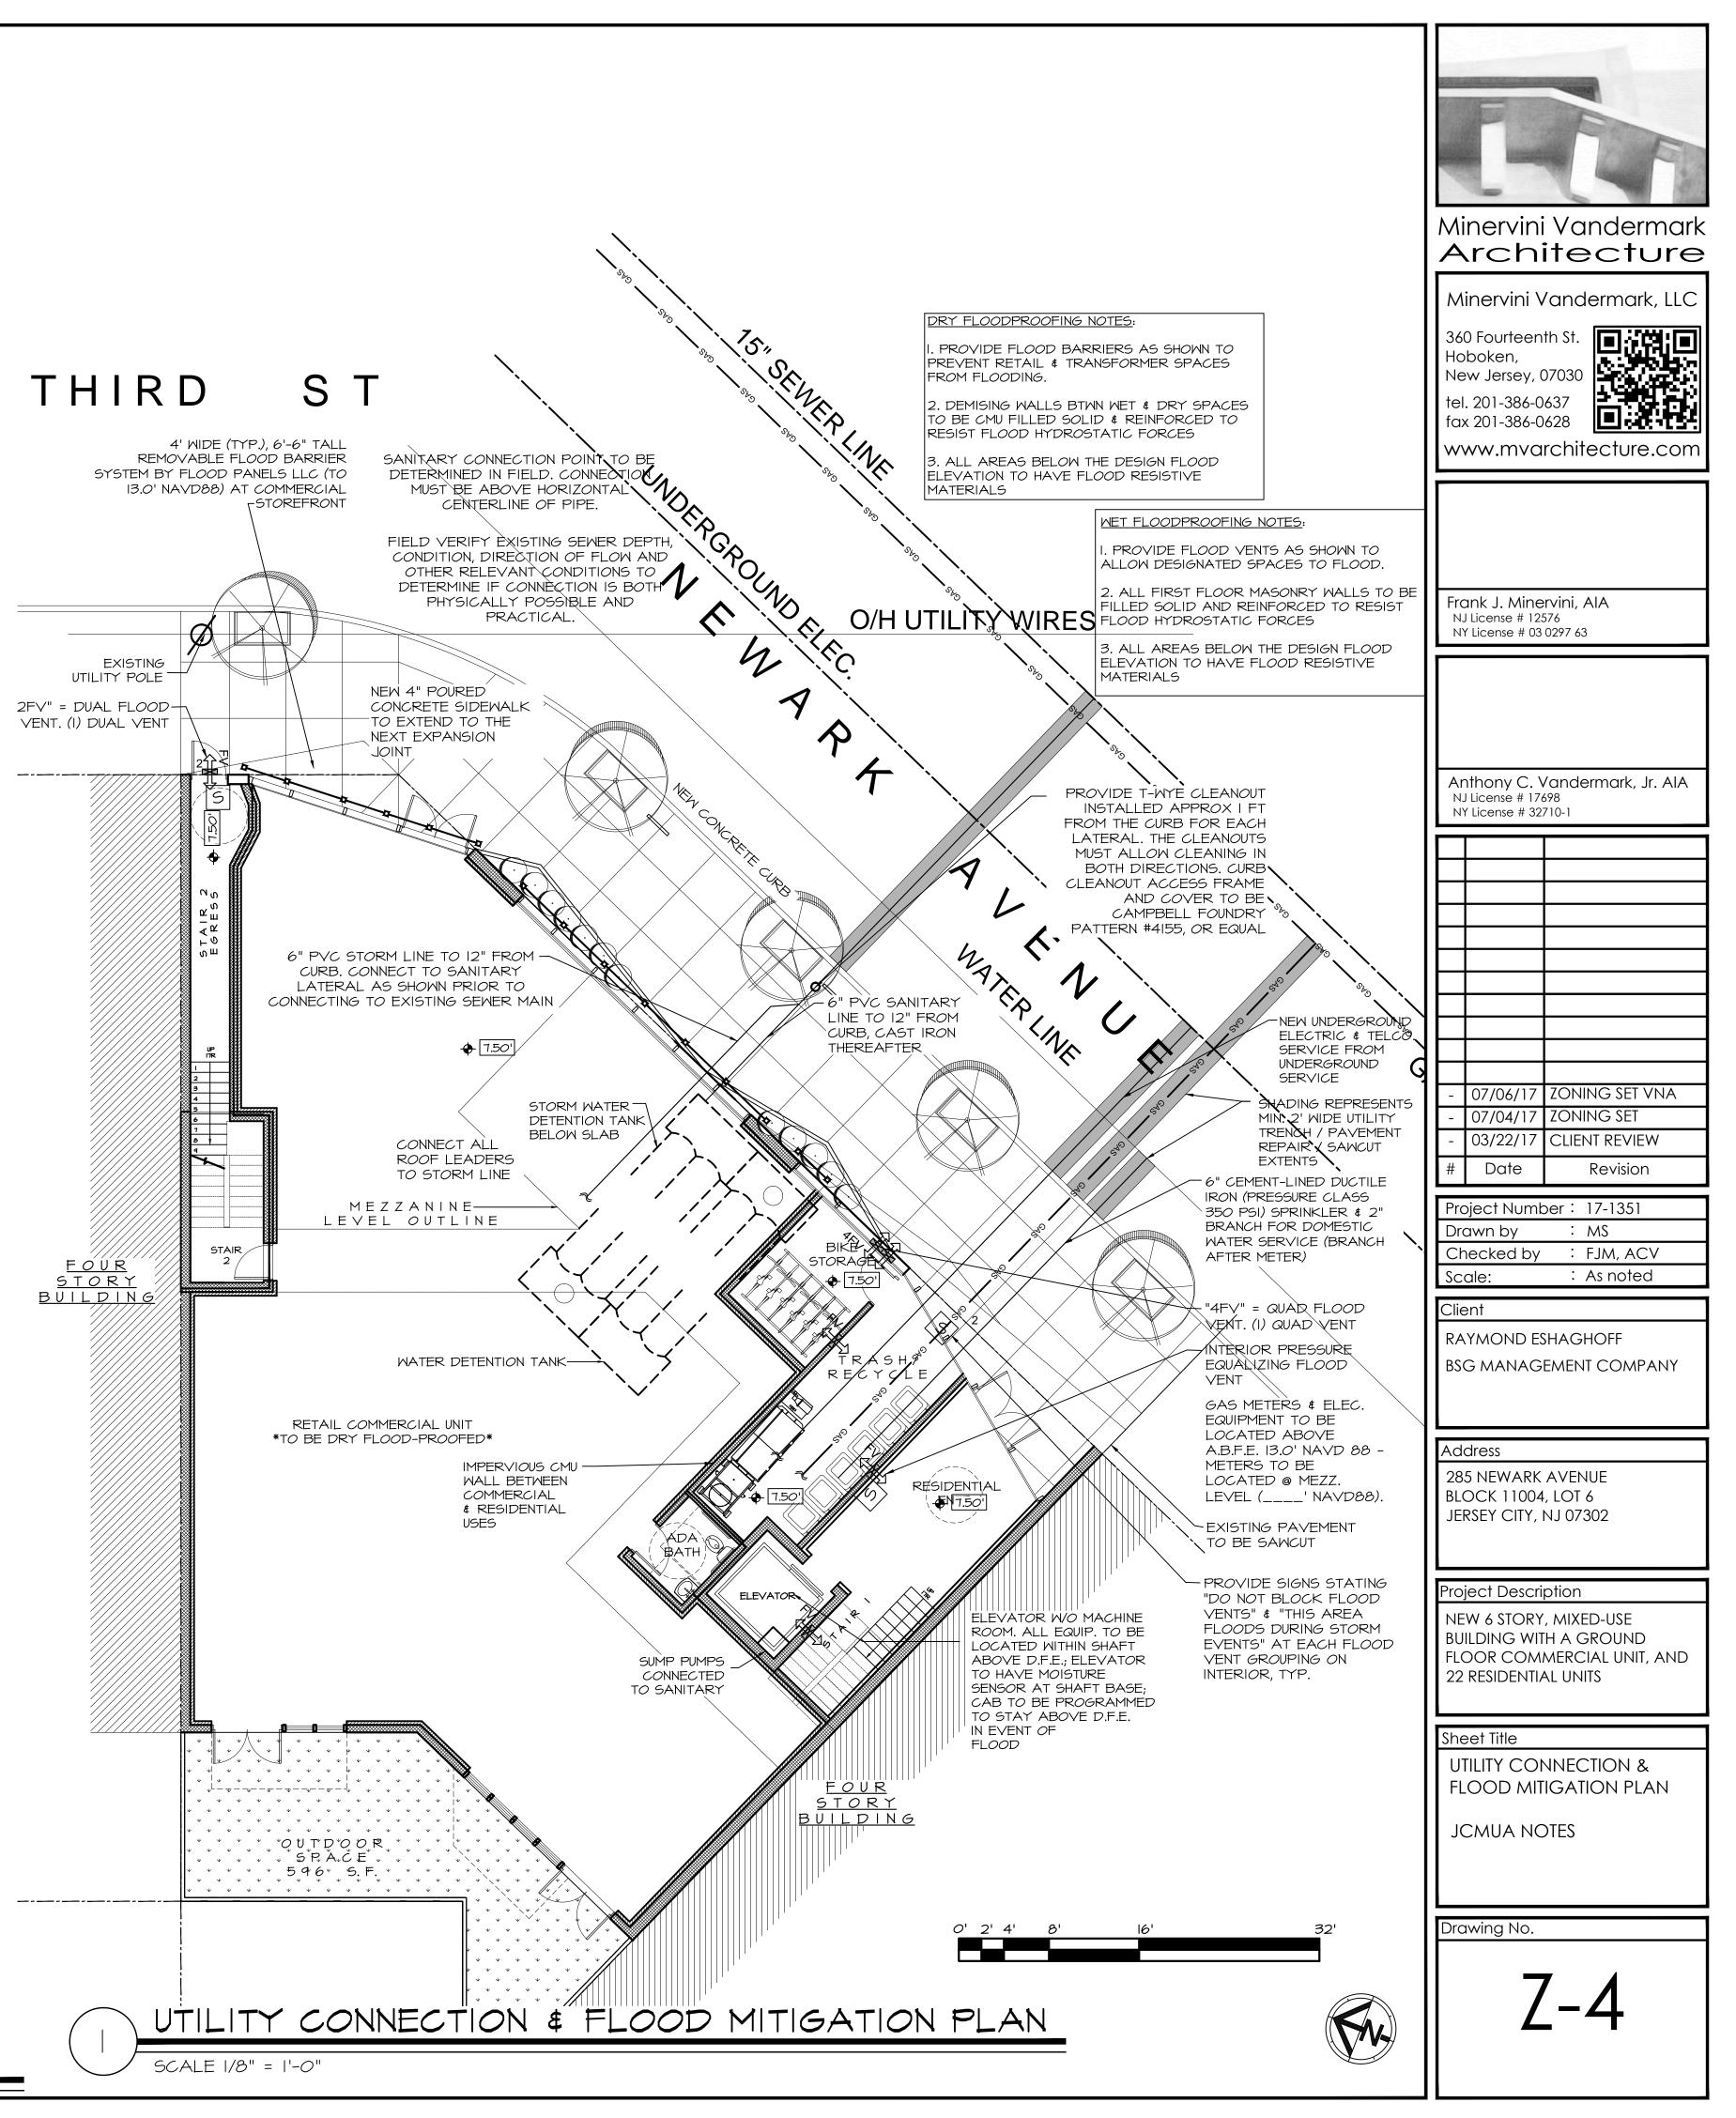

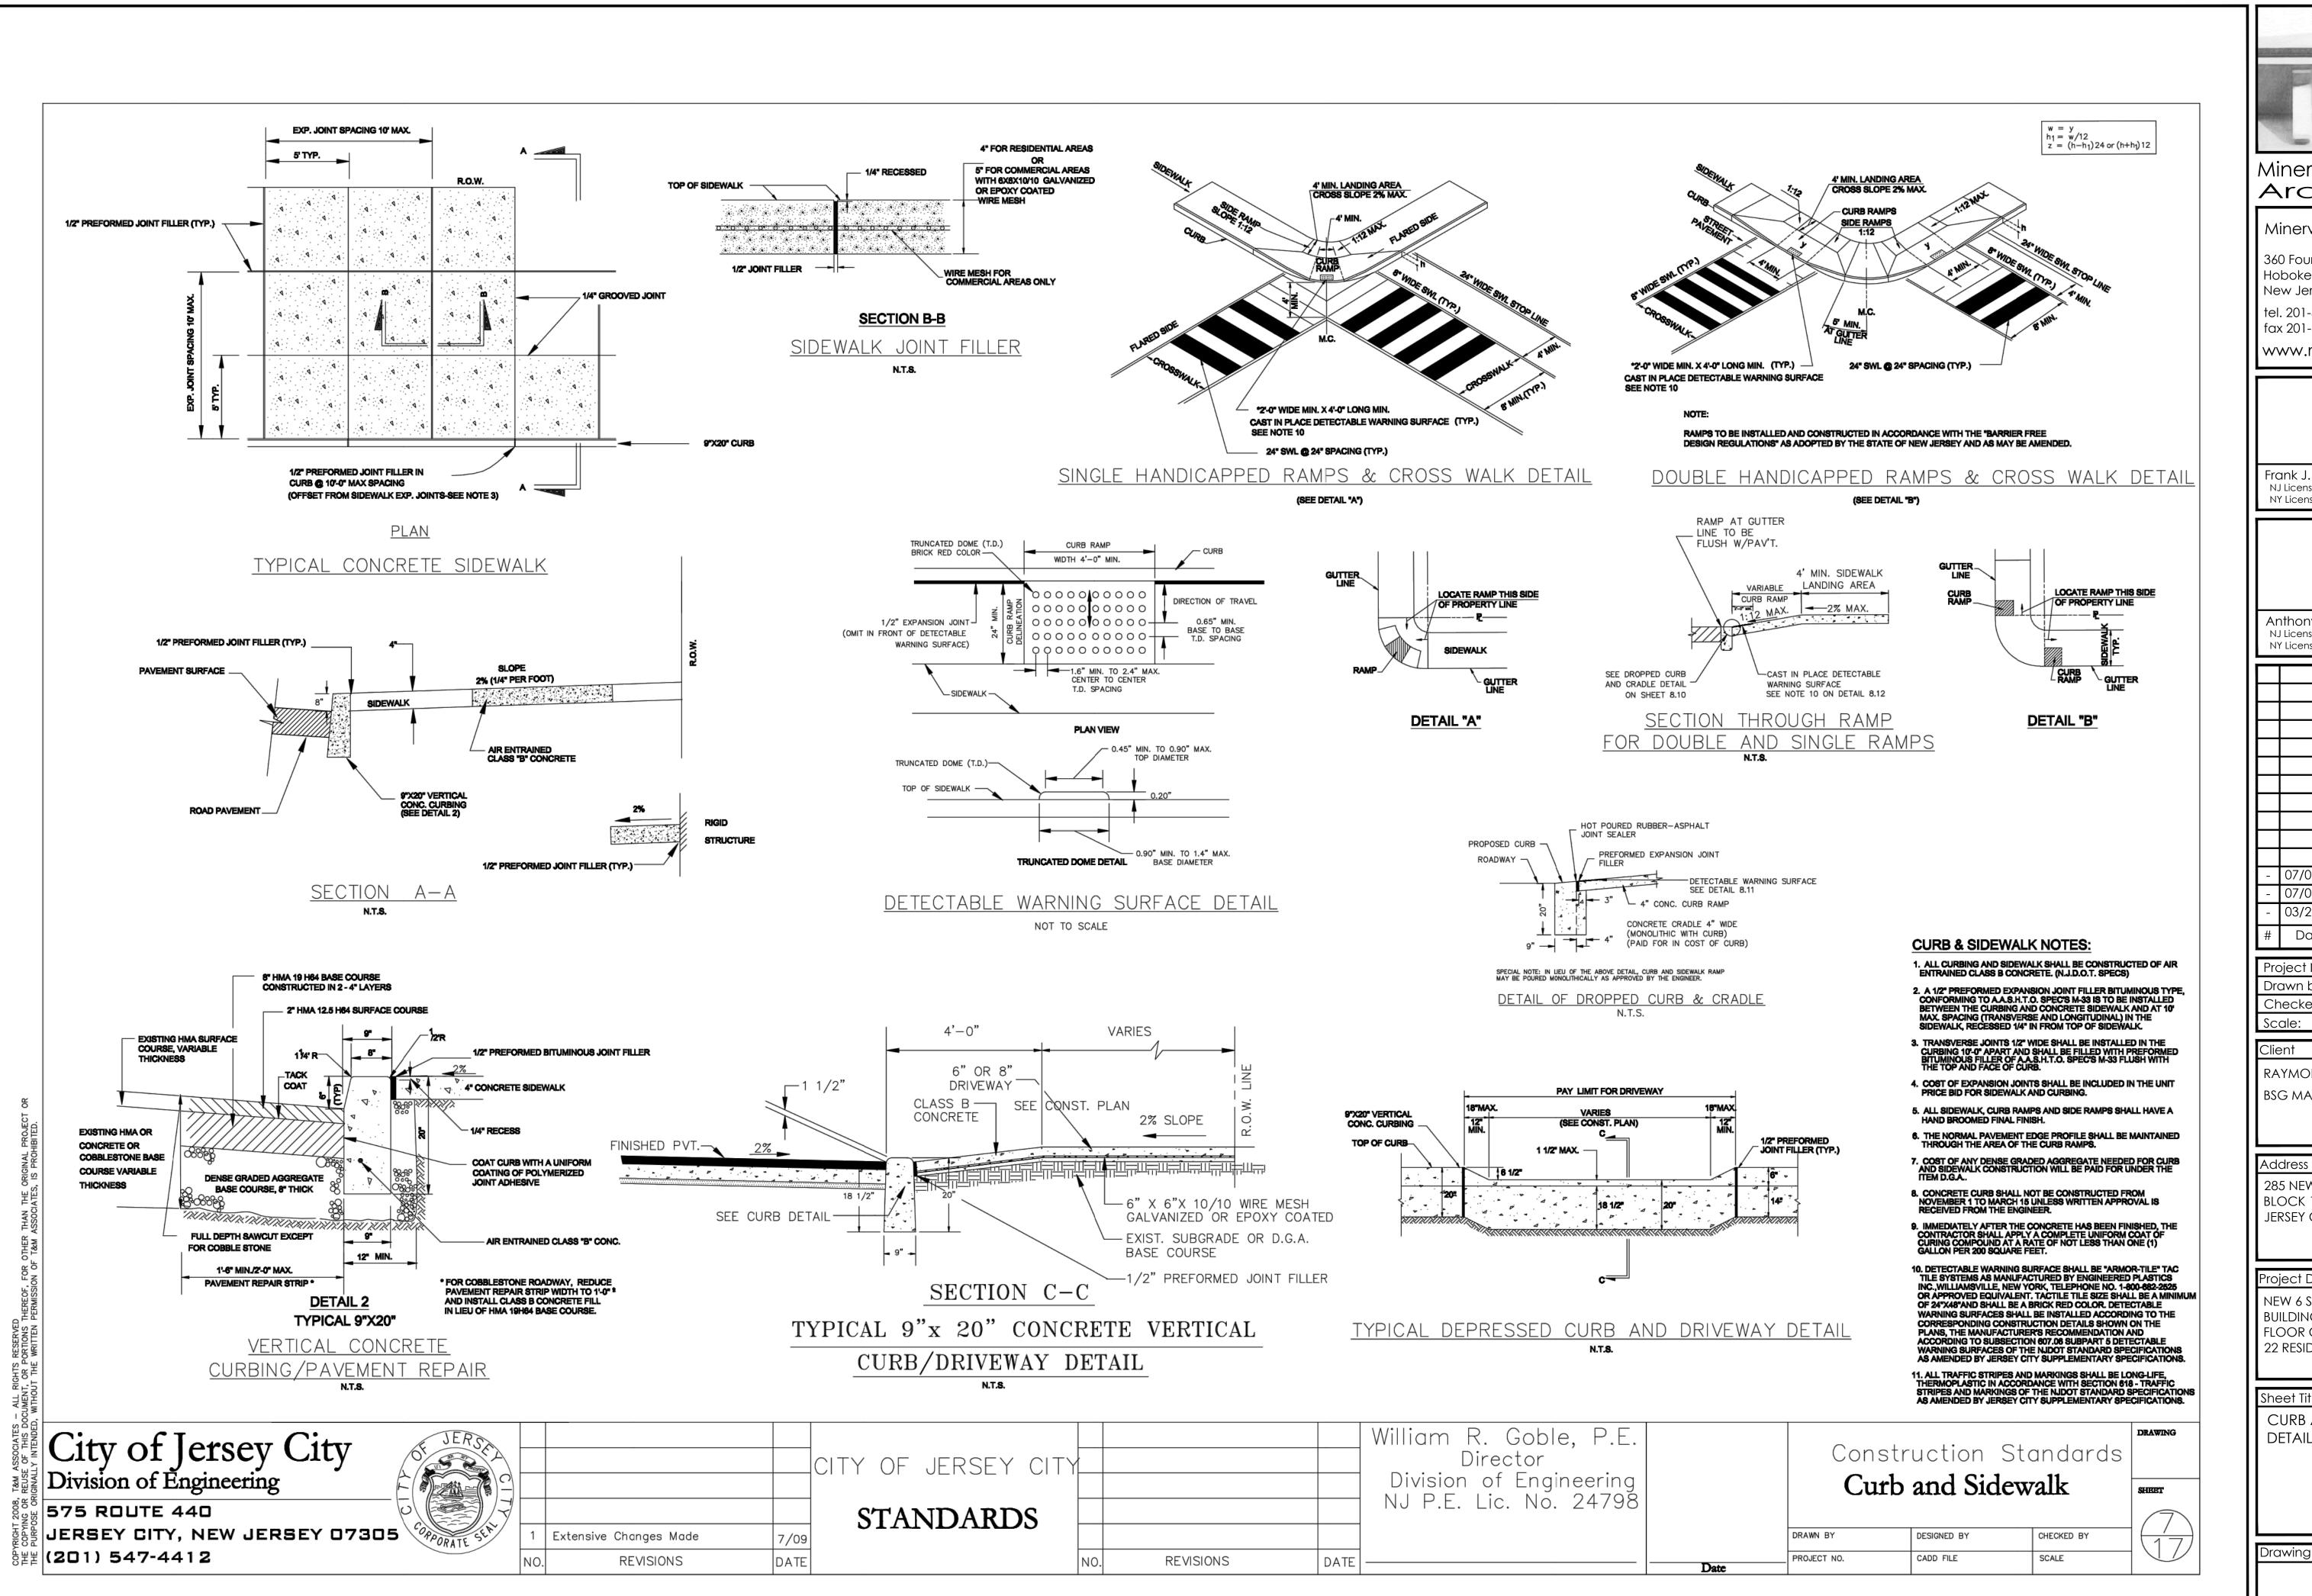


		Vandermark			
360 Ho Ne tel	0 Fourteen boken, w Jersey, (. 201-386-0 < 201-386-0	07030 637			
N.	ank J. Mine License # 12: License # 03	576			
Ν.	nthony C. \ 1 License # 176 7 License # 32				
- - #	07/04/17 03/22/17 Date	ZONING SET VNA ZONING SET CLIENT REVIEW Revision			
Dro Ch Sco Clie RA	Project Number : 17-1351 Drawn by : MS Checked by : FJM, ACV Scale: : As noted Client RAYMOND ESHAGHOFF BSG MANAGEMENT COMPANY				
Address 285 NEWARK AVENUE BLOCK 11004, LOT 6 JERSEY CITY, NJ 07302					
Project Description NEW 6 STORY, MIXED-USE BUILDING WITH A GROUND FLOOR COMMERCIAL UNIT, AND 22 RESIDENTIAL UNITS					
Sheet Title CURB AND SIDEWALK DETAILS					
Drc	Drawing No.				

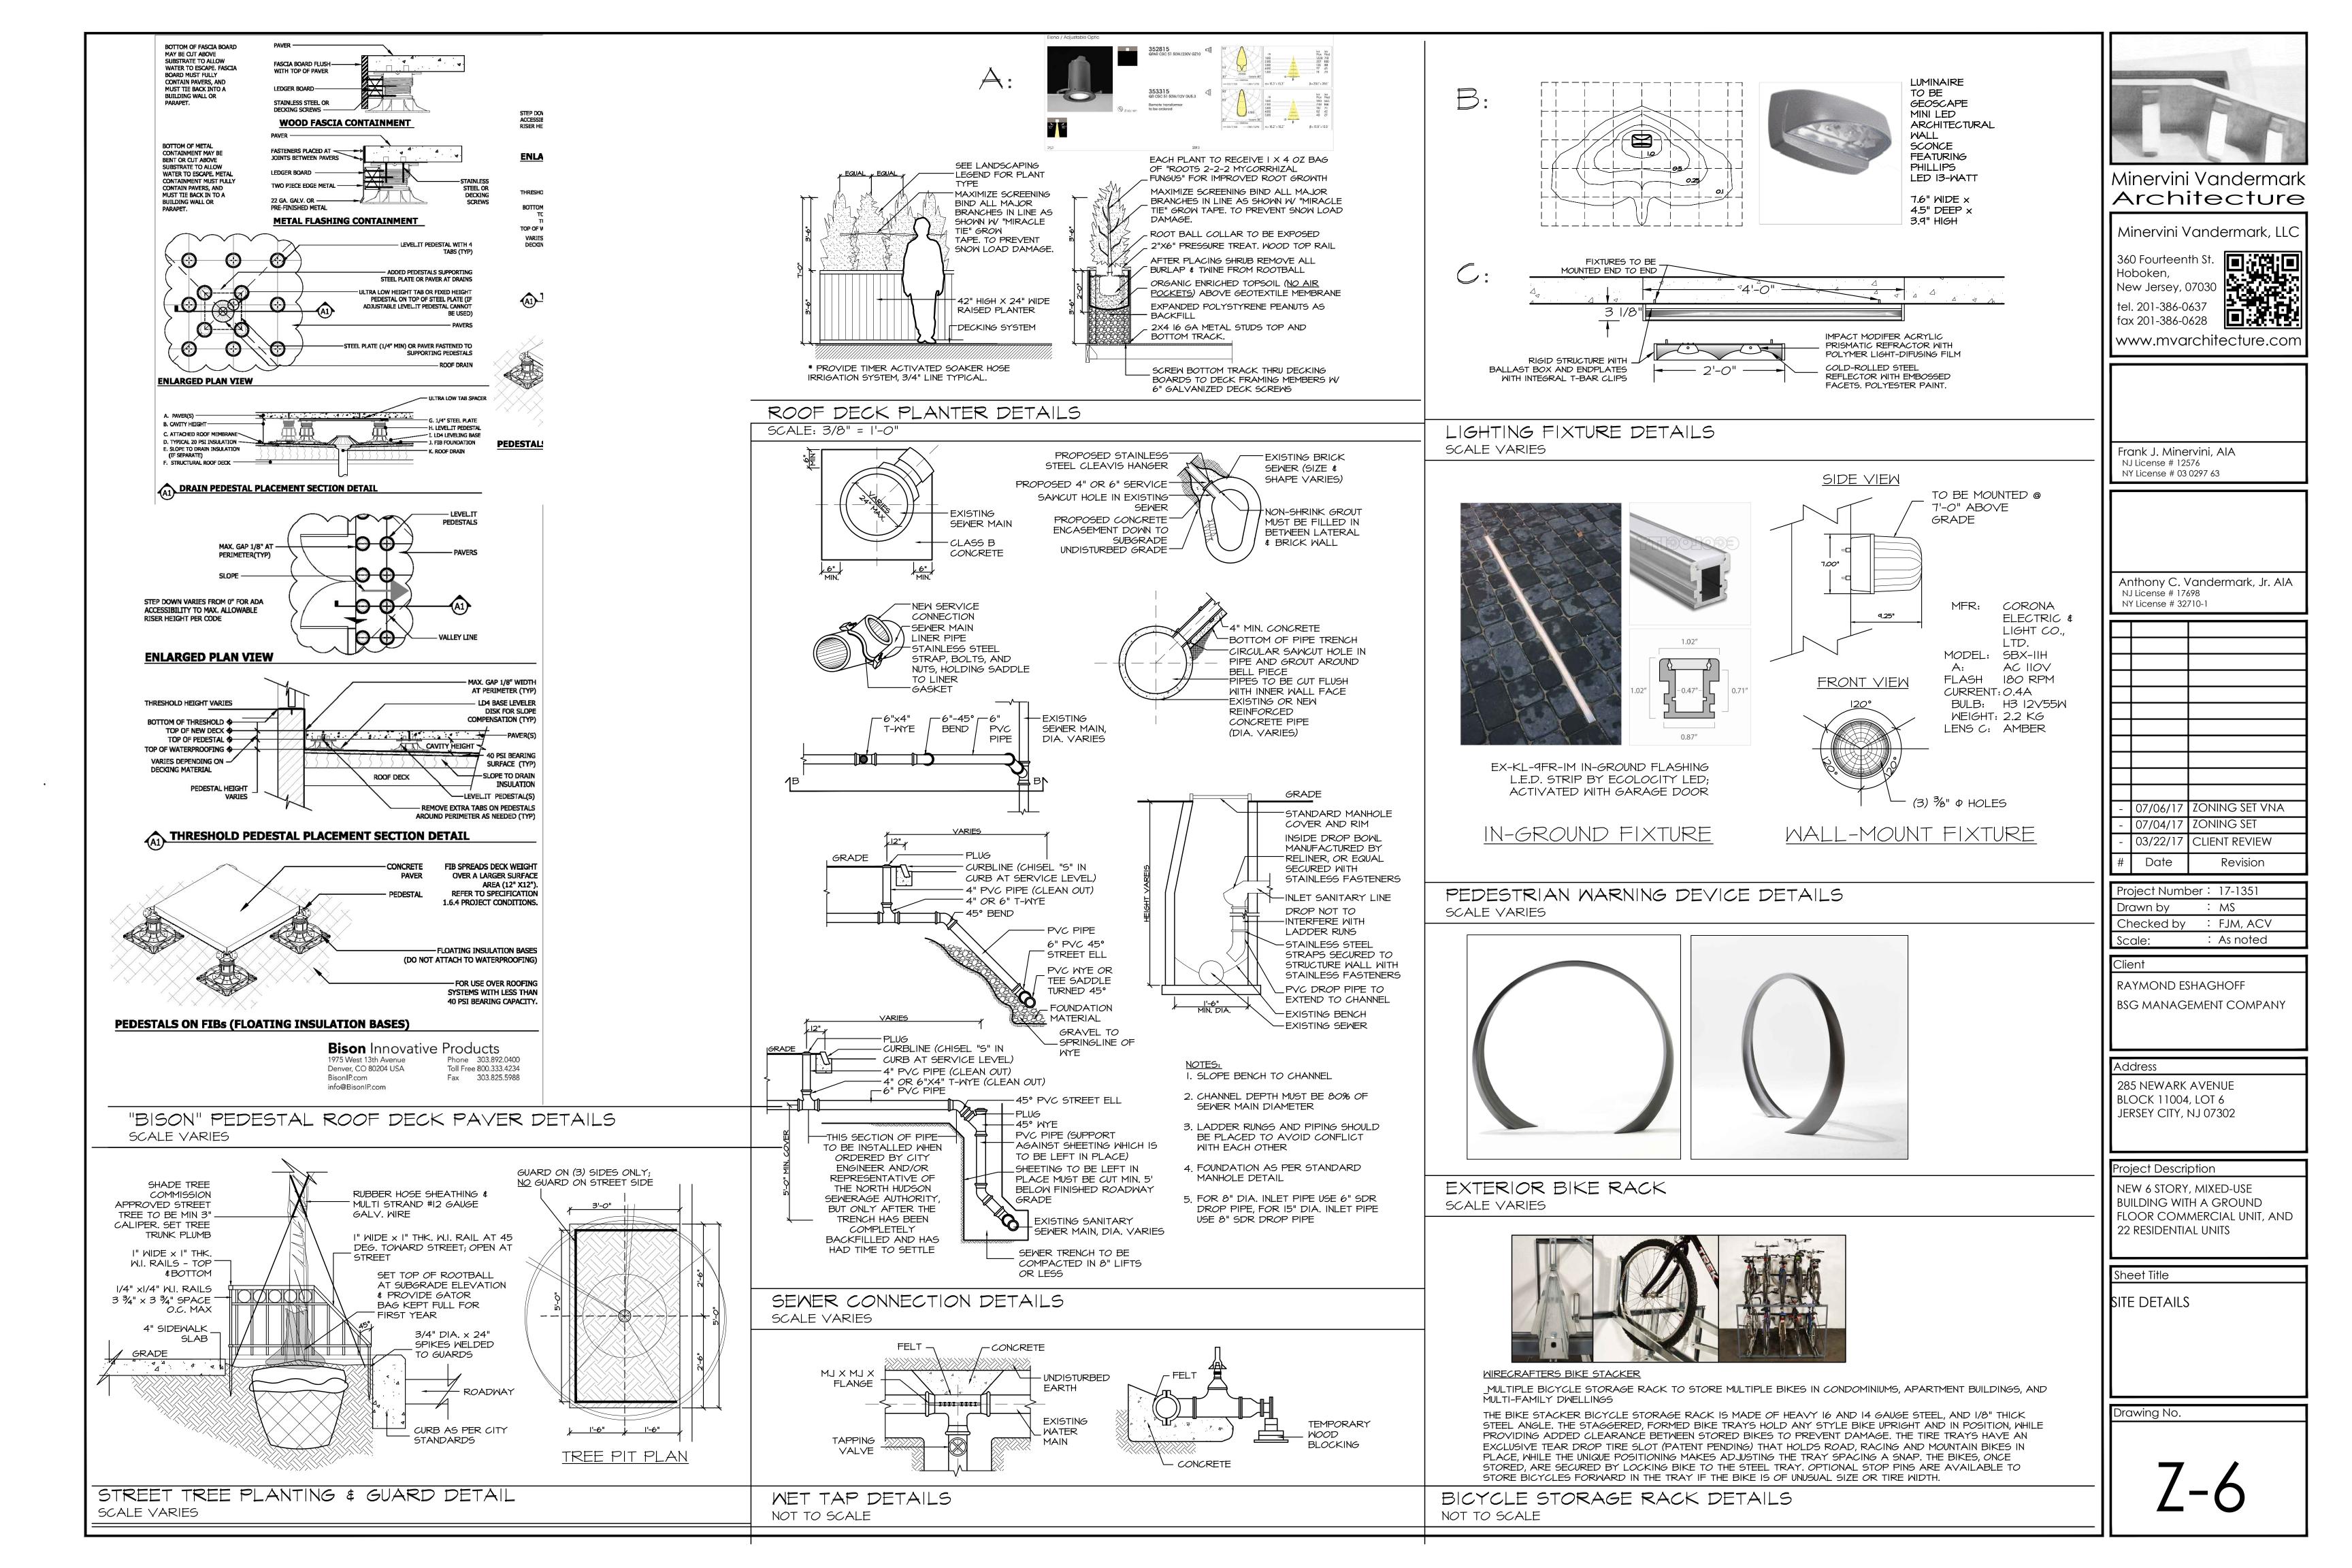

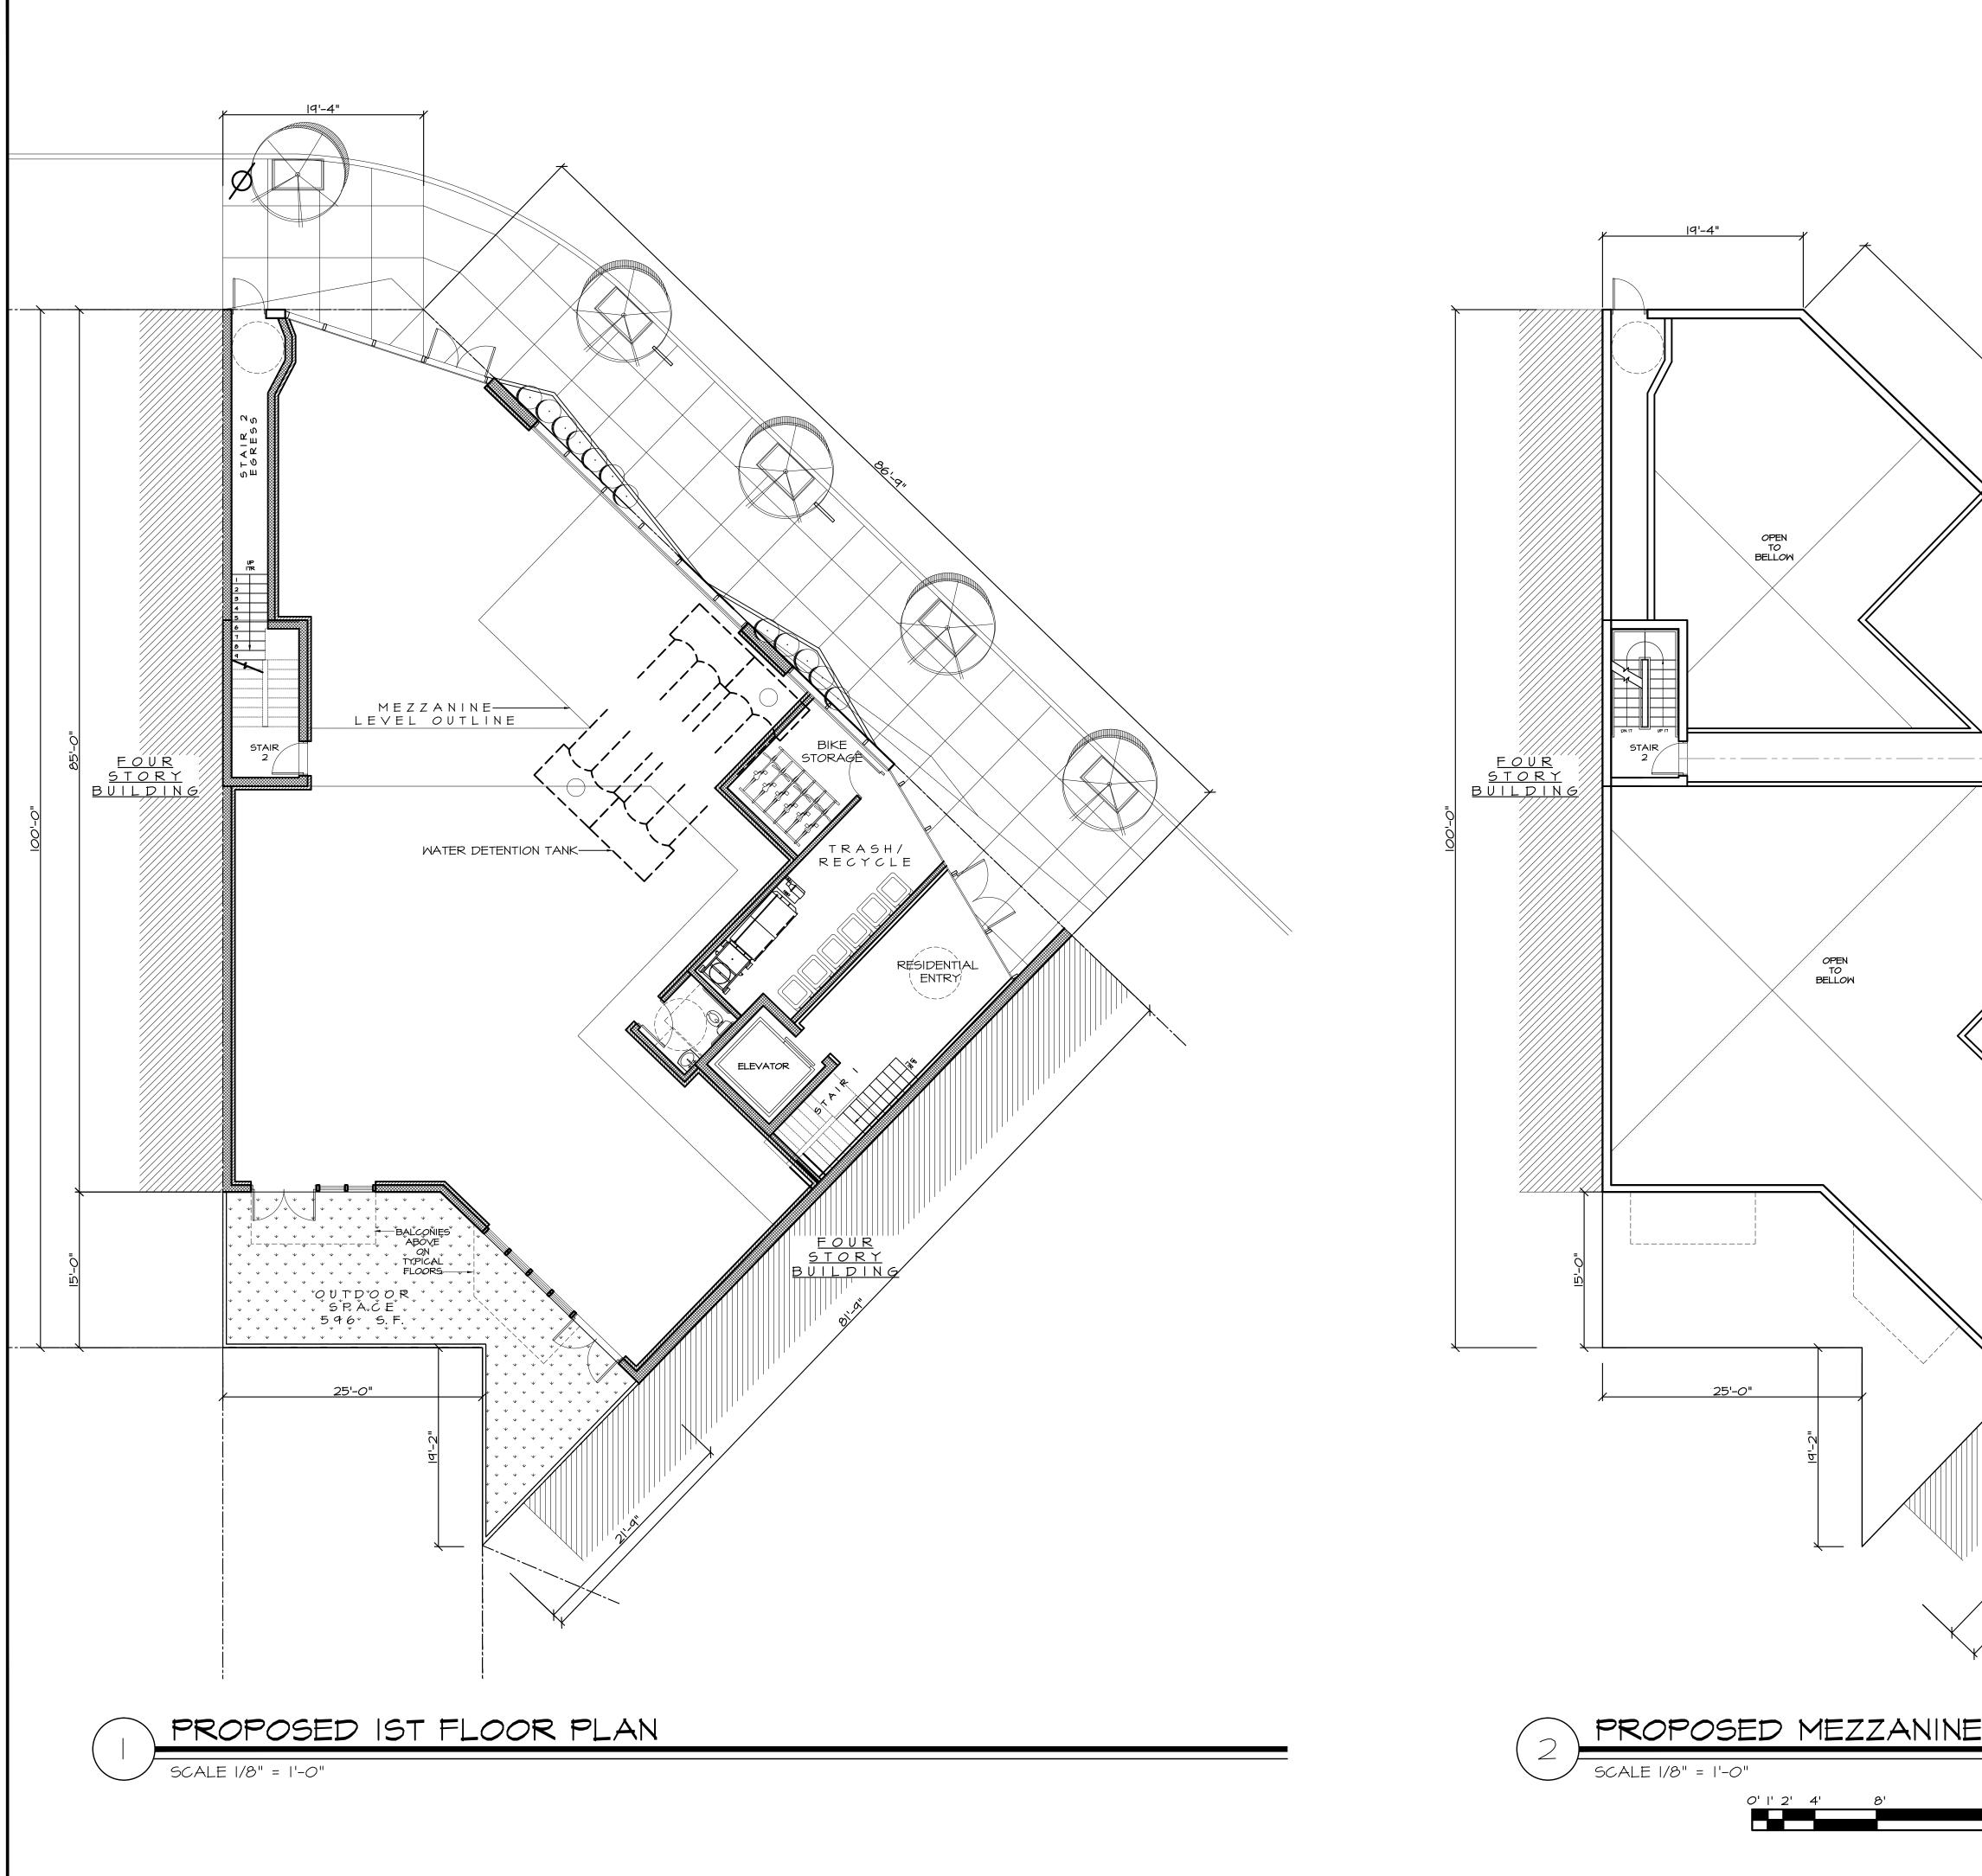



•

	<image/> <section-header>Minervini Vandermark ArchitectureMinervini Vandermark ArchitectureMinervini Vandermark ArchitectureMinervini Vandermark ArchitectureSéo Fourteenth St. Hoboken, New Jersey, 07030 tel. 201-386-0637 fax 201-386-0638Image: State of the state of t</section-header>
	Frank J. Minervini, AIA NJ License # 12576 NY License # 03 0297 63
MEZZANINE LEVEL I,6891 S.F.	Anthony C. Vandermark, Jr. AIA NJ License # 17698 NY License # 32710-1
CAS METERS BELLOW ELEVATOR	Image: Second state of the second s
START START START BUILDING 000 BUILDING 010 BUILDING 010 BUILDING	Client RAYMOND ESHAGHOFF BSG MANAGEMENT COMPANY Address 285 NEWARK AVENUE BLOCK 11004, LOT 6 JERSEY CITY, NJ 07302
	Project Description NEW 6 STORY, MIXED-USE BUILDING WITH A GROUND FLOOR COMMERCIAL UNIT, AND 22 RESIDENTIAL UNITS
E LEVEL	PROPOSED FLOOR PLANS: 1ST FLOOR MEZZANINE LEVEL Drawing No.
16' 32'	Z-7

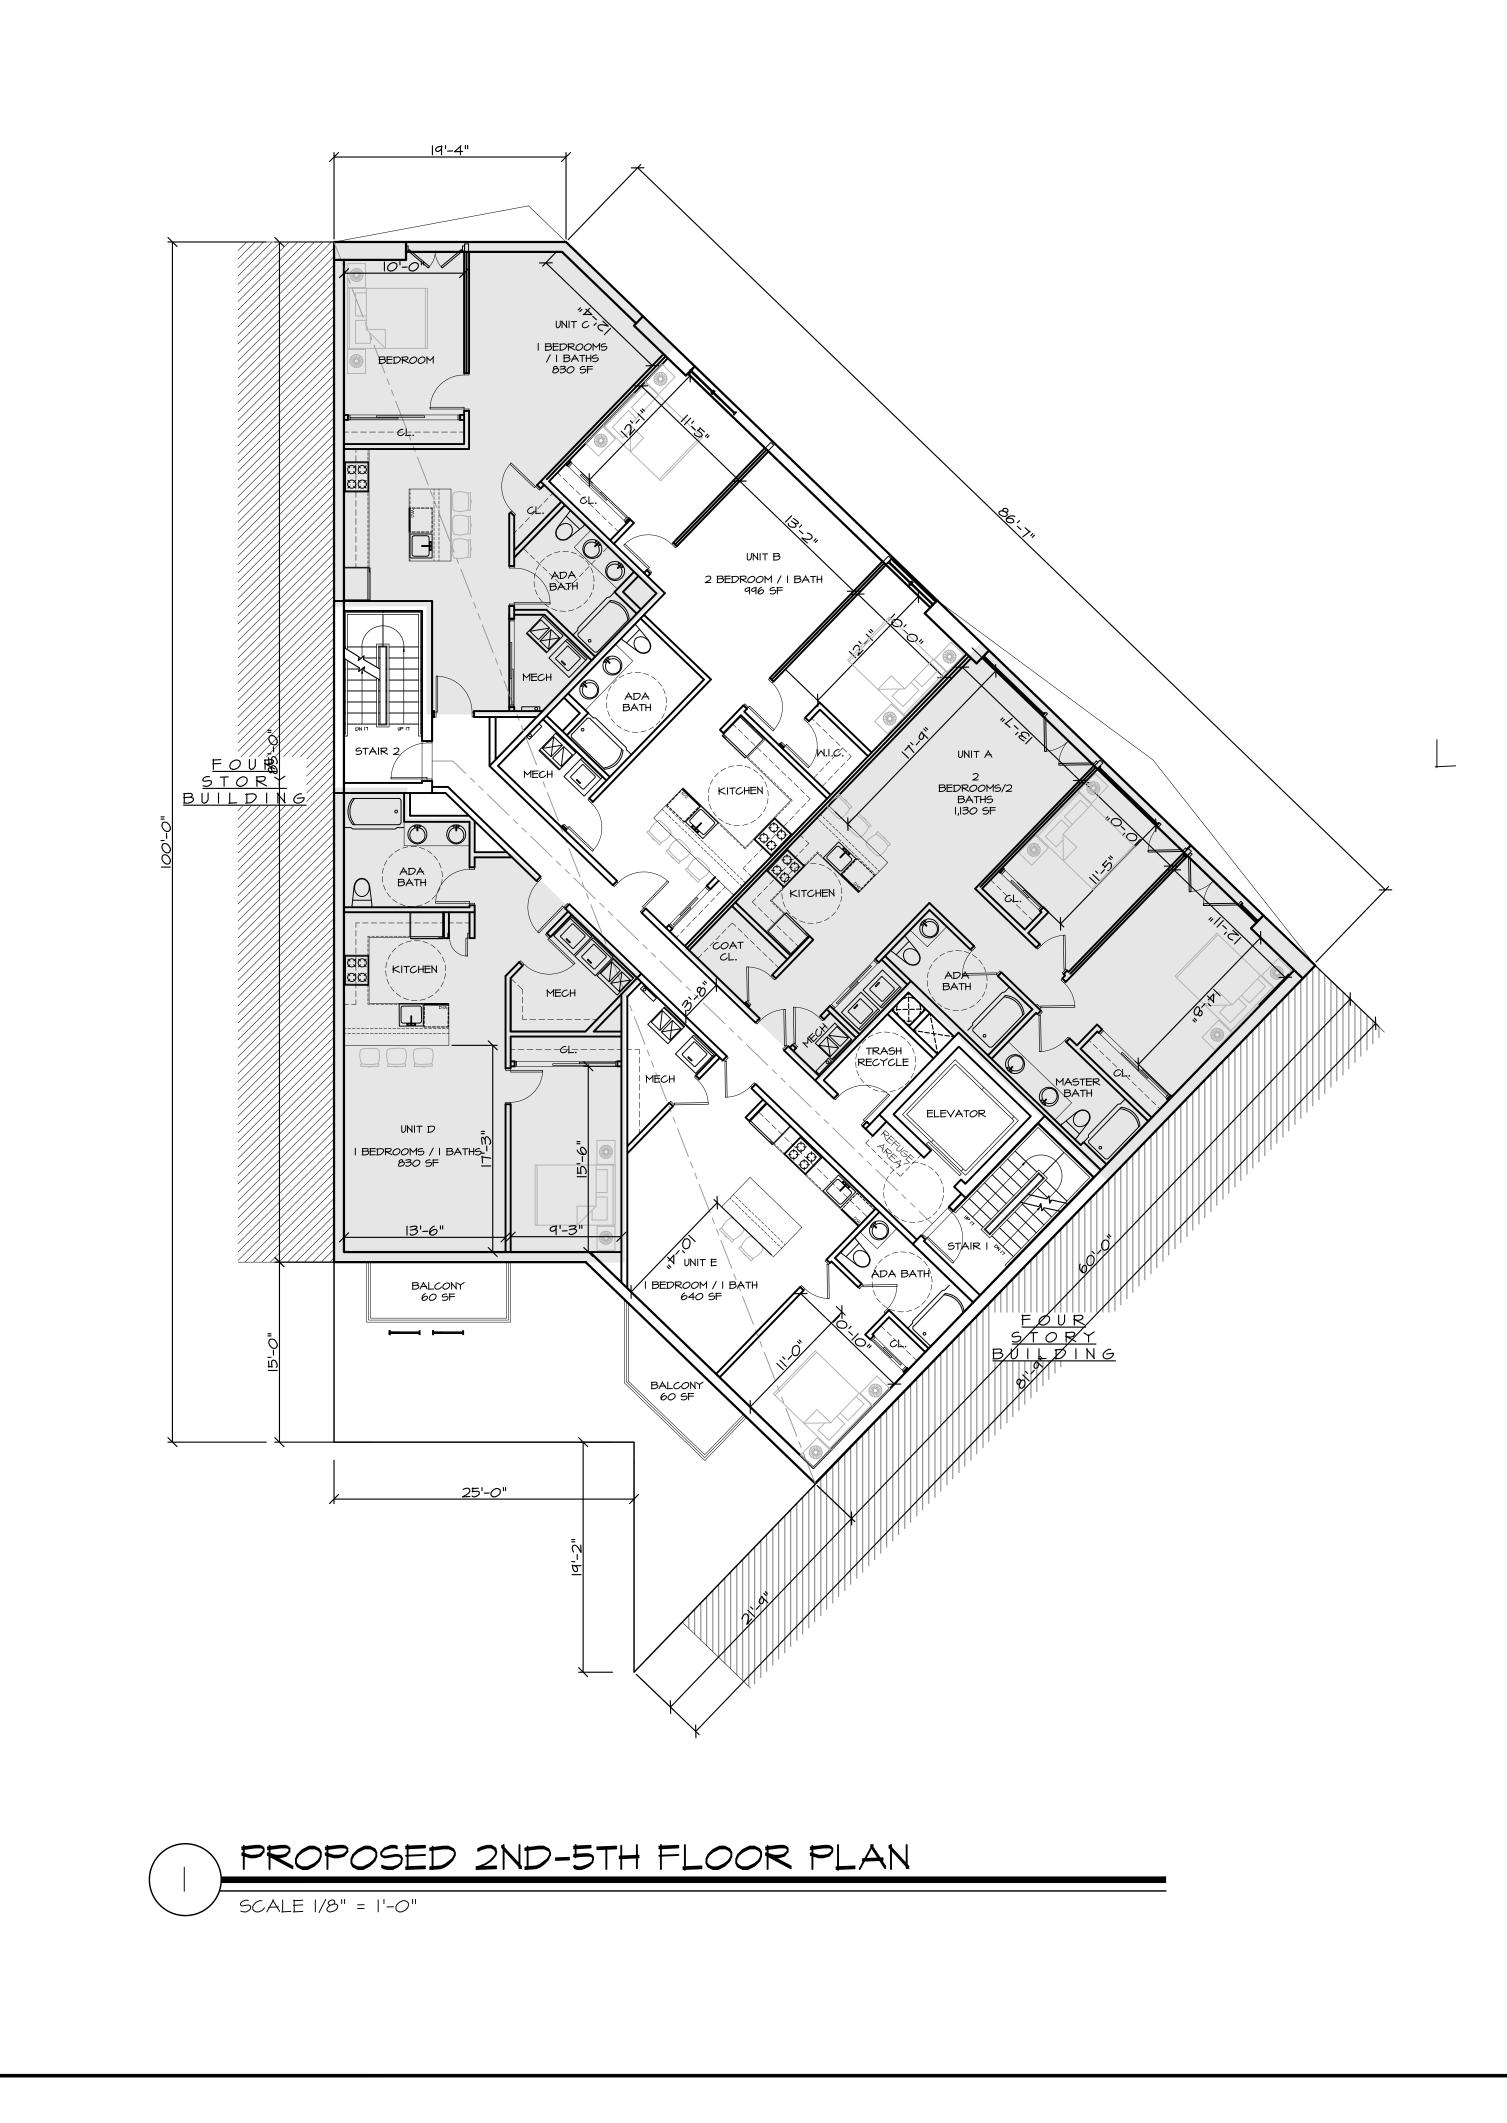



•

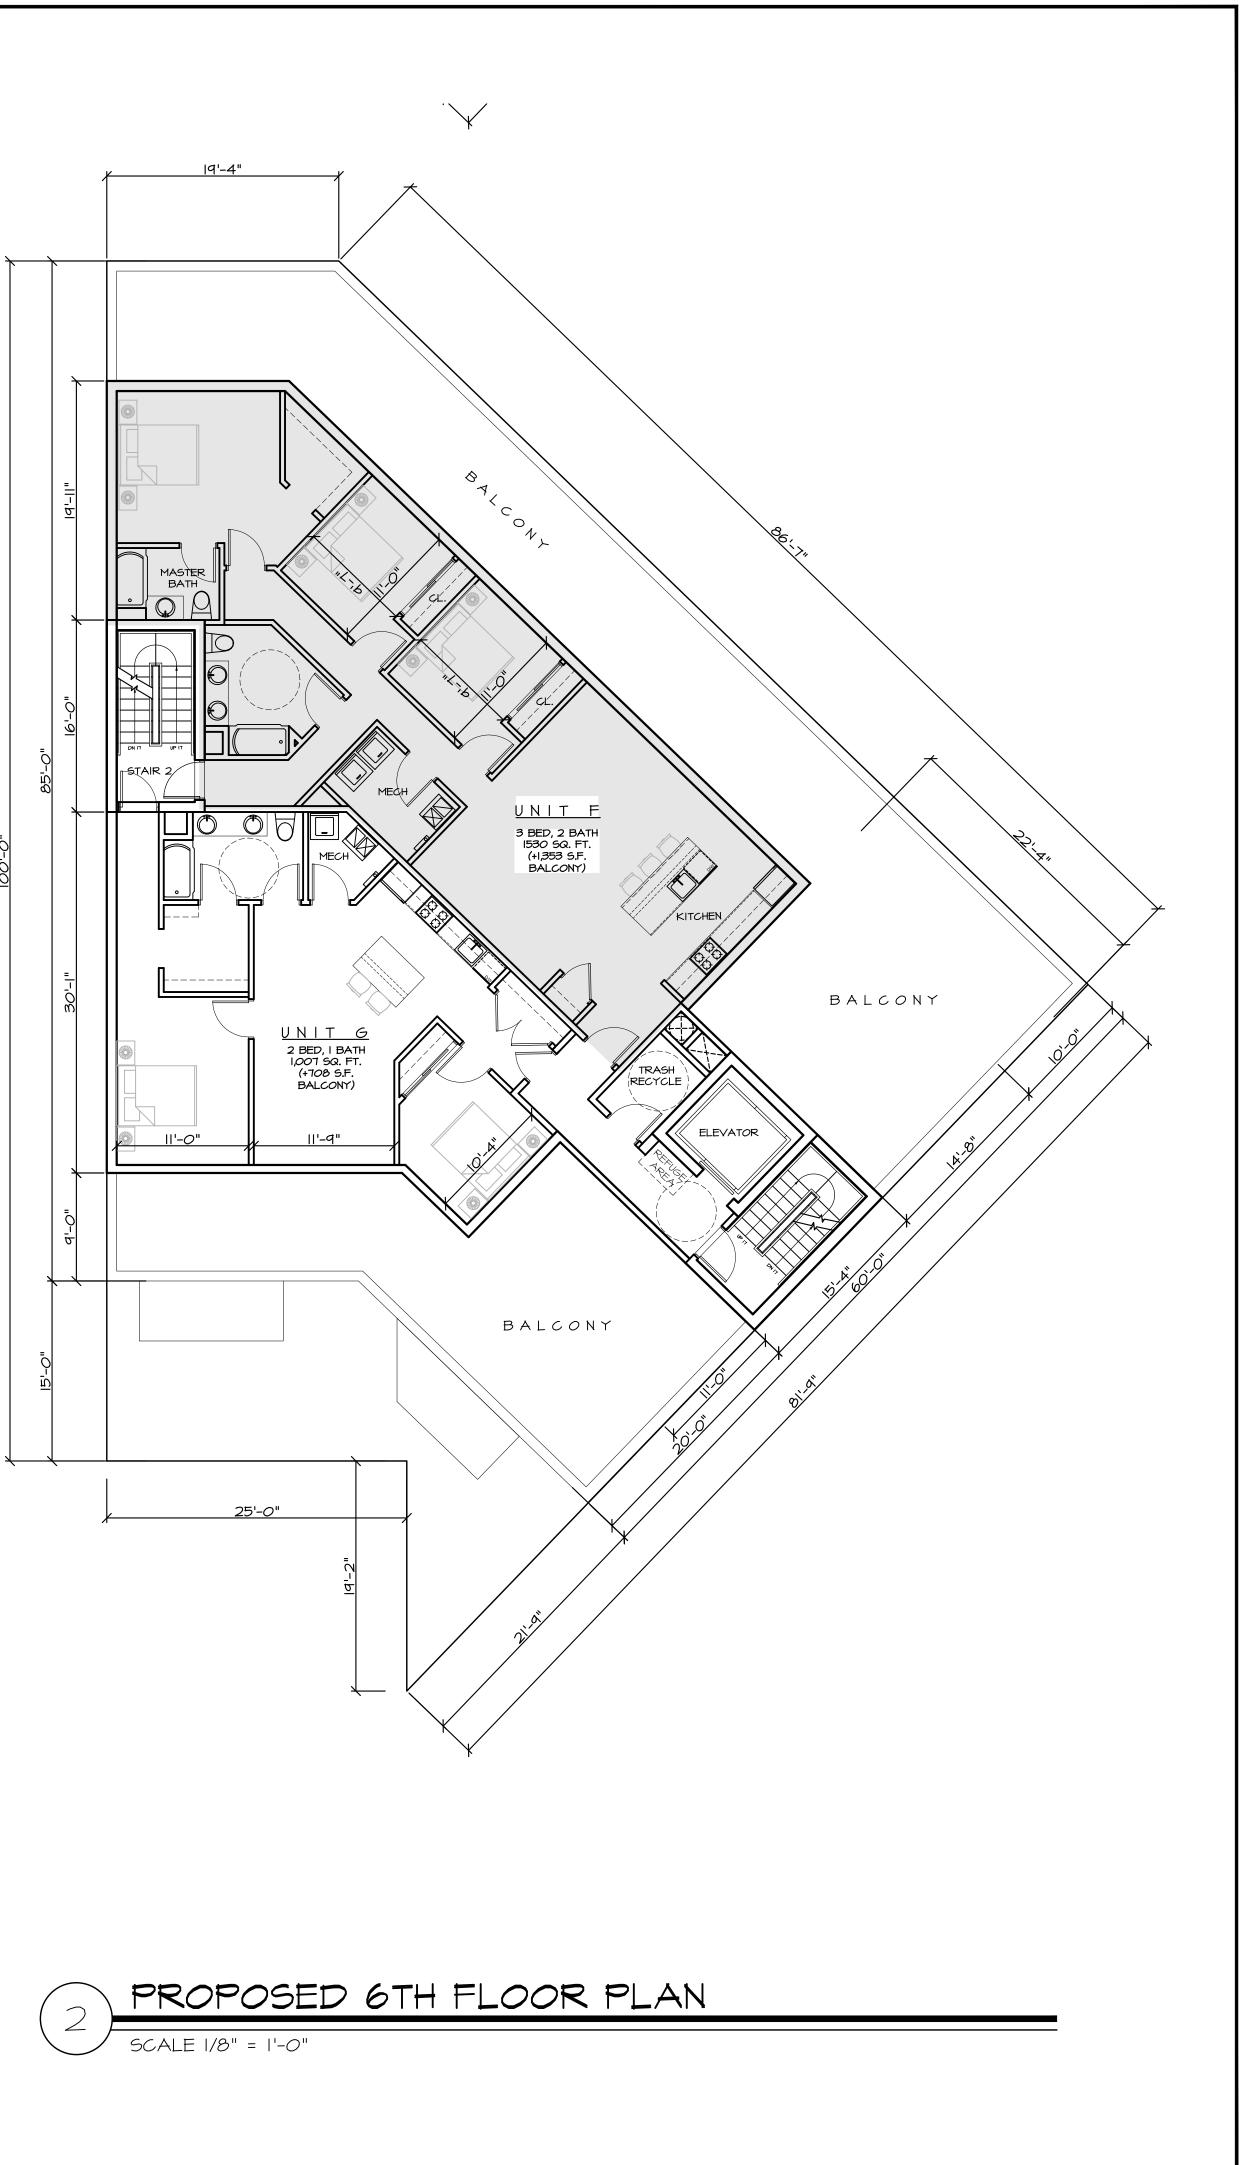

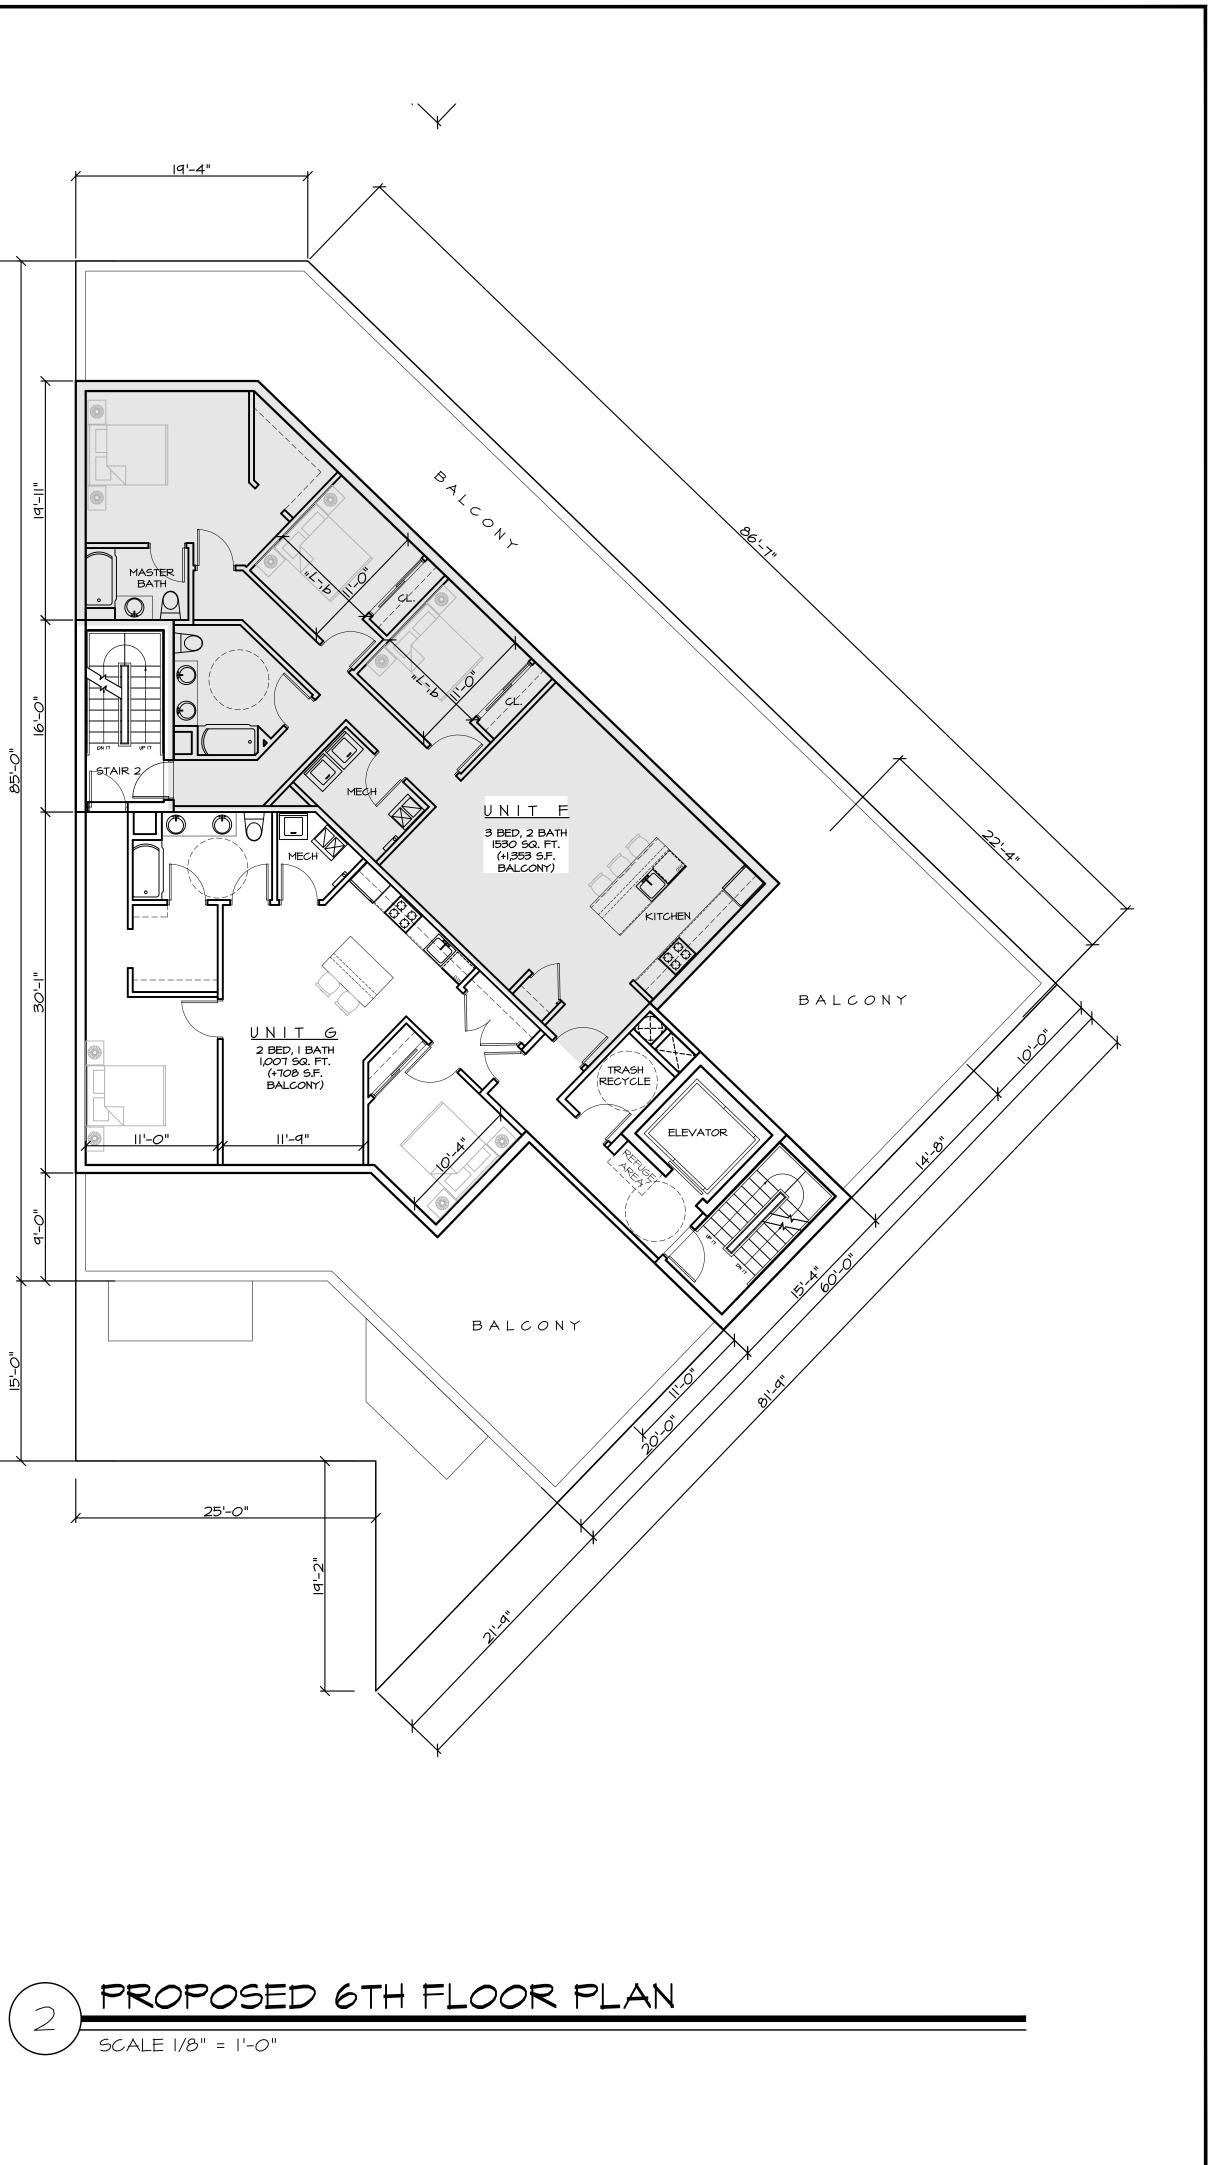

Minervini Vandermark				
Architecture Minervini Vandermark, LLC 360 Fourteenth St. Hoboken, New Jersey, 07030 tel. 201-386-0637 fax 201-386-0628 www.mvarchitecture.com				
Frank J. Minervini, AIA NJ License # 12576 NY License # 03 0297 63				
Anthony C. Vandermark, Jr. AlA NJ License # 17698 NY License # 32710-1				
- 07/06/17 ZONING SET VNA				
-07/04/17ZONING SET-03/22/17CLIENT REVIEW#DateRevisionProject Number :17-1351Drawn by:MSChecked by:FJM, ACVScale::As noted				
Client RAYMOND ESHAGHOFF BSG MANAGEMENT COMPANY Address 285 NEWARK AVENUE BLOCK 11004, LOT 6				
Project Description NEW 6 STORY, MIXED-USE BUILDING WITH A GROUND FLOOR COMMERCIAL UNIT, AND 22 RESIDENTIAL UNITS				
Sheet Title PROPOSED 2ND-5TH FLOOR PLAN PROPOSED 6TH FLOOR PLAN				
Drawing No.				

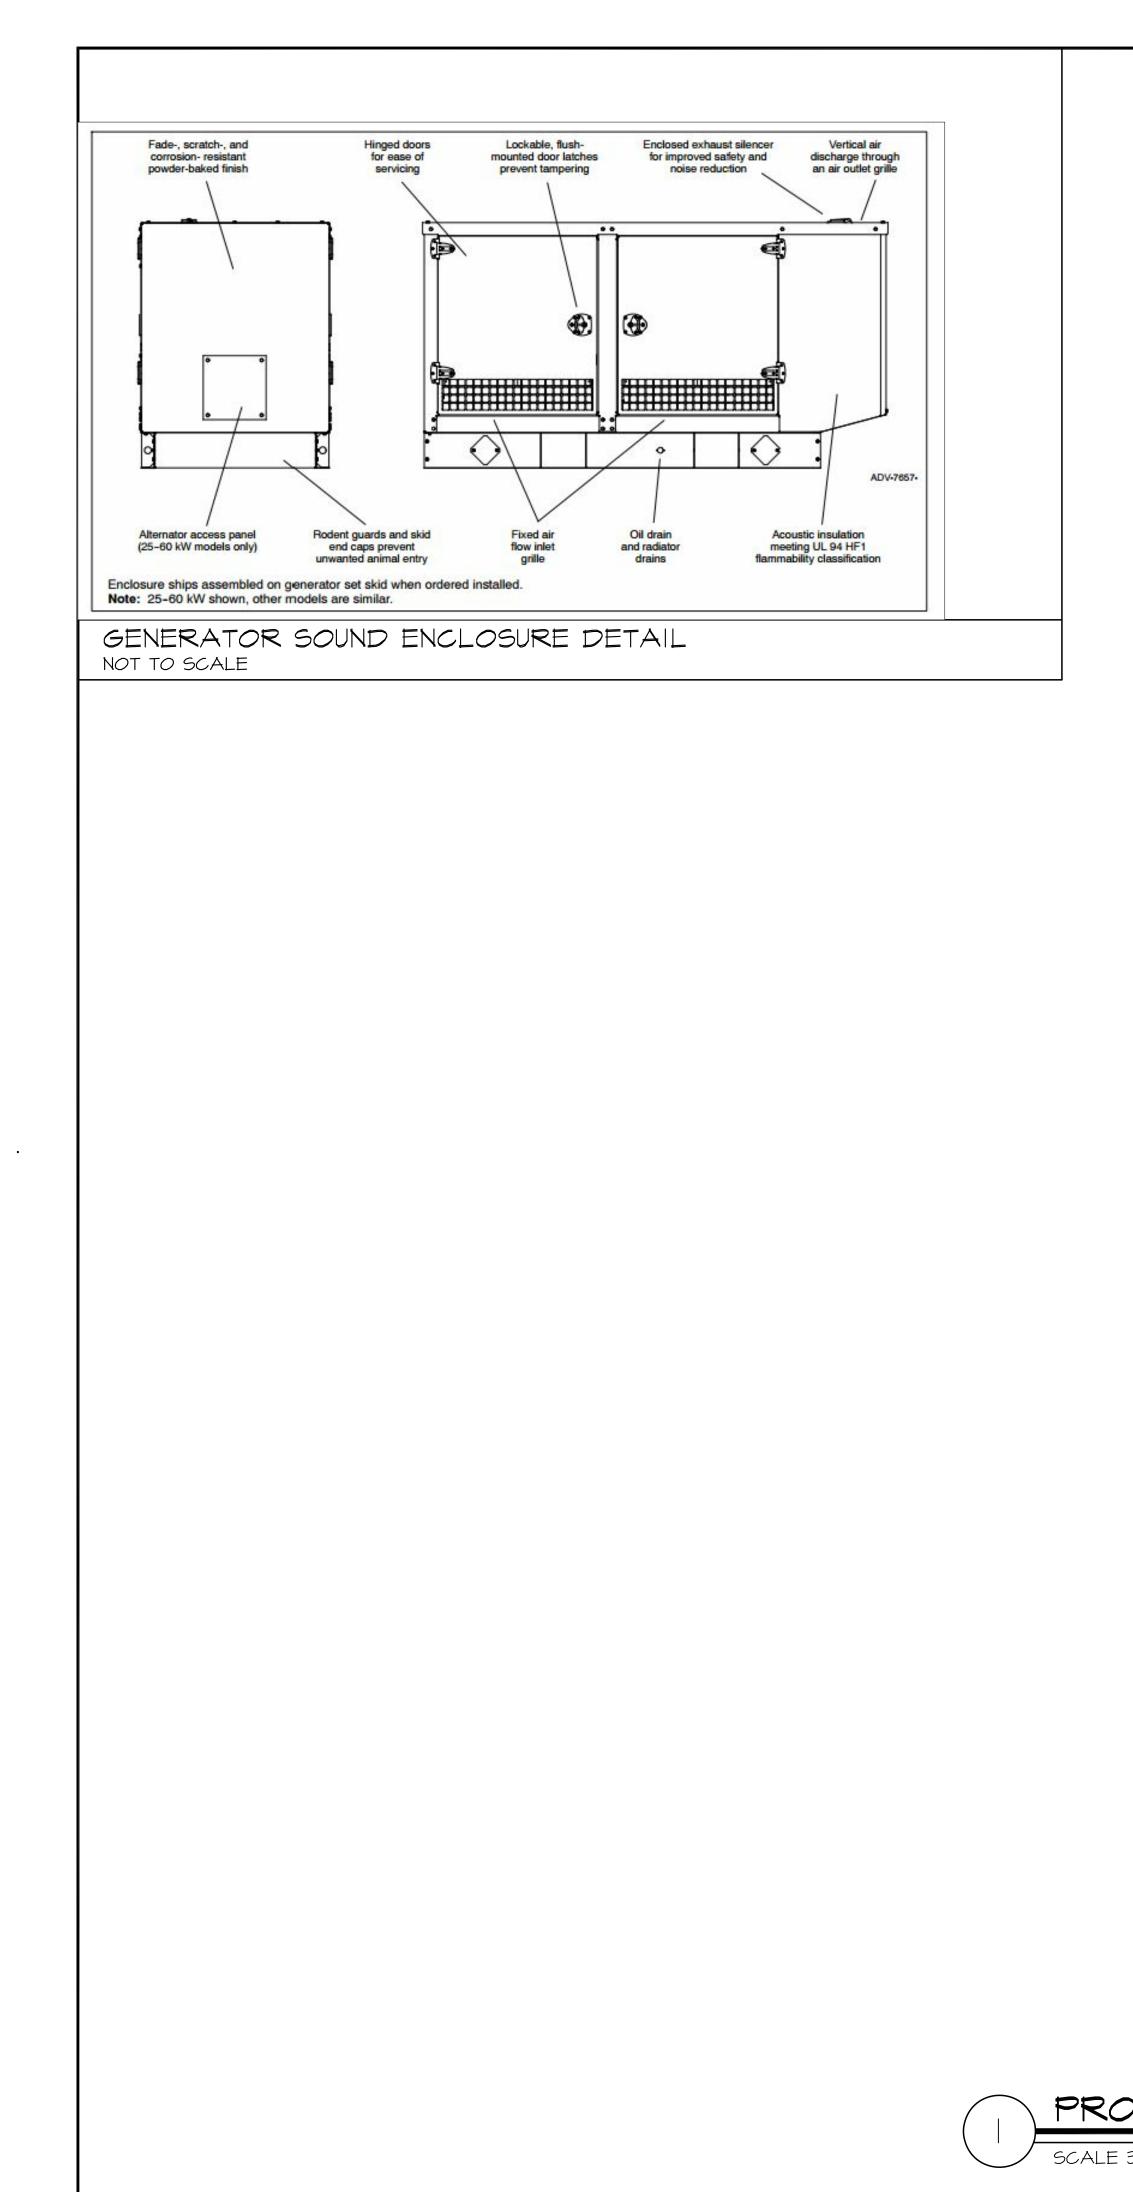

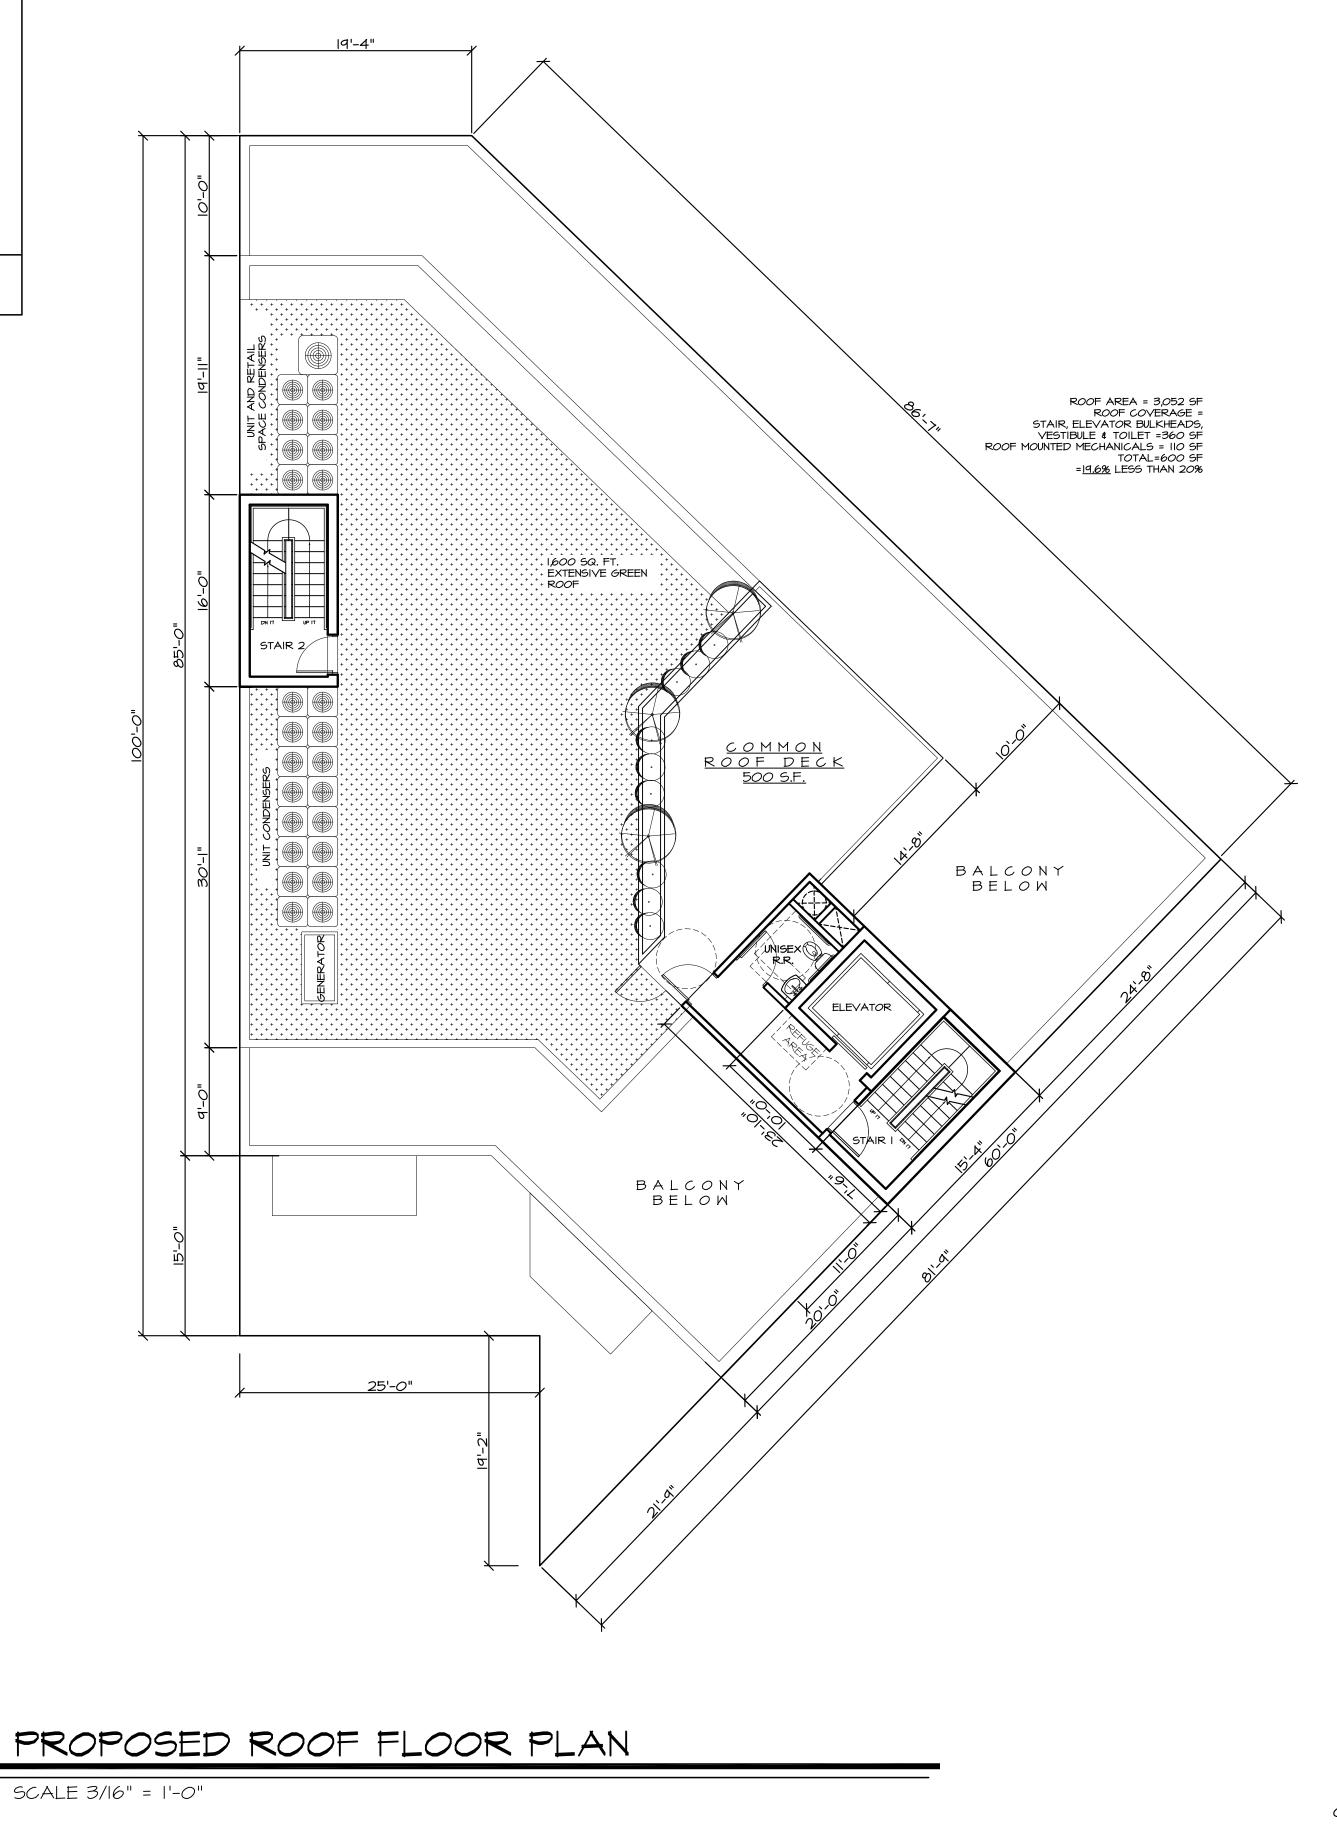


	rchi	Vandermark itecture			
Hob Nev tel.	Fourteen, ooken, v Jersey, (201-386-0 201-386-0 / W.MV a	07030 637			
NJI	nk J. Mine License # 125 License # 03	576			
NJ l	hony C. V License # 176 License # 323				
H					
	07/06/17 07/04/17	ZONING SET VNA ZONING SET			
-	03/22/17	CLIENT REVIEW			
#	Date	Revision			
Dra	wn by	ber: 17-1351 : MS			
Che Sca	ecked by lle:	: FJM, ACV : As noted			
RAY	Client RAYMOND ESHAGHOFF BSG MANAGEMENT COMPANY				
285 BLO	285 NEWARK AVENUE BLOCK 11004, LOT 6 JERSEY CITY, NJ 07302				
	ect Descri V 6 STORY	ption , MIXED-USE			
BUIL Flo 22 F	BUILDING WITH A GROUND FLOOR COMMERCIAL UNIT, AND 22 RESIDENTIAL UNITS				
		6TH FLOOR			
Drav	Drawing No.				
	Z	<u> </u>			


0' |' 2' 4' 8'





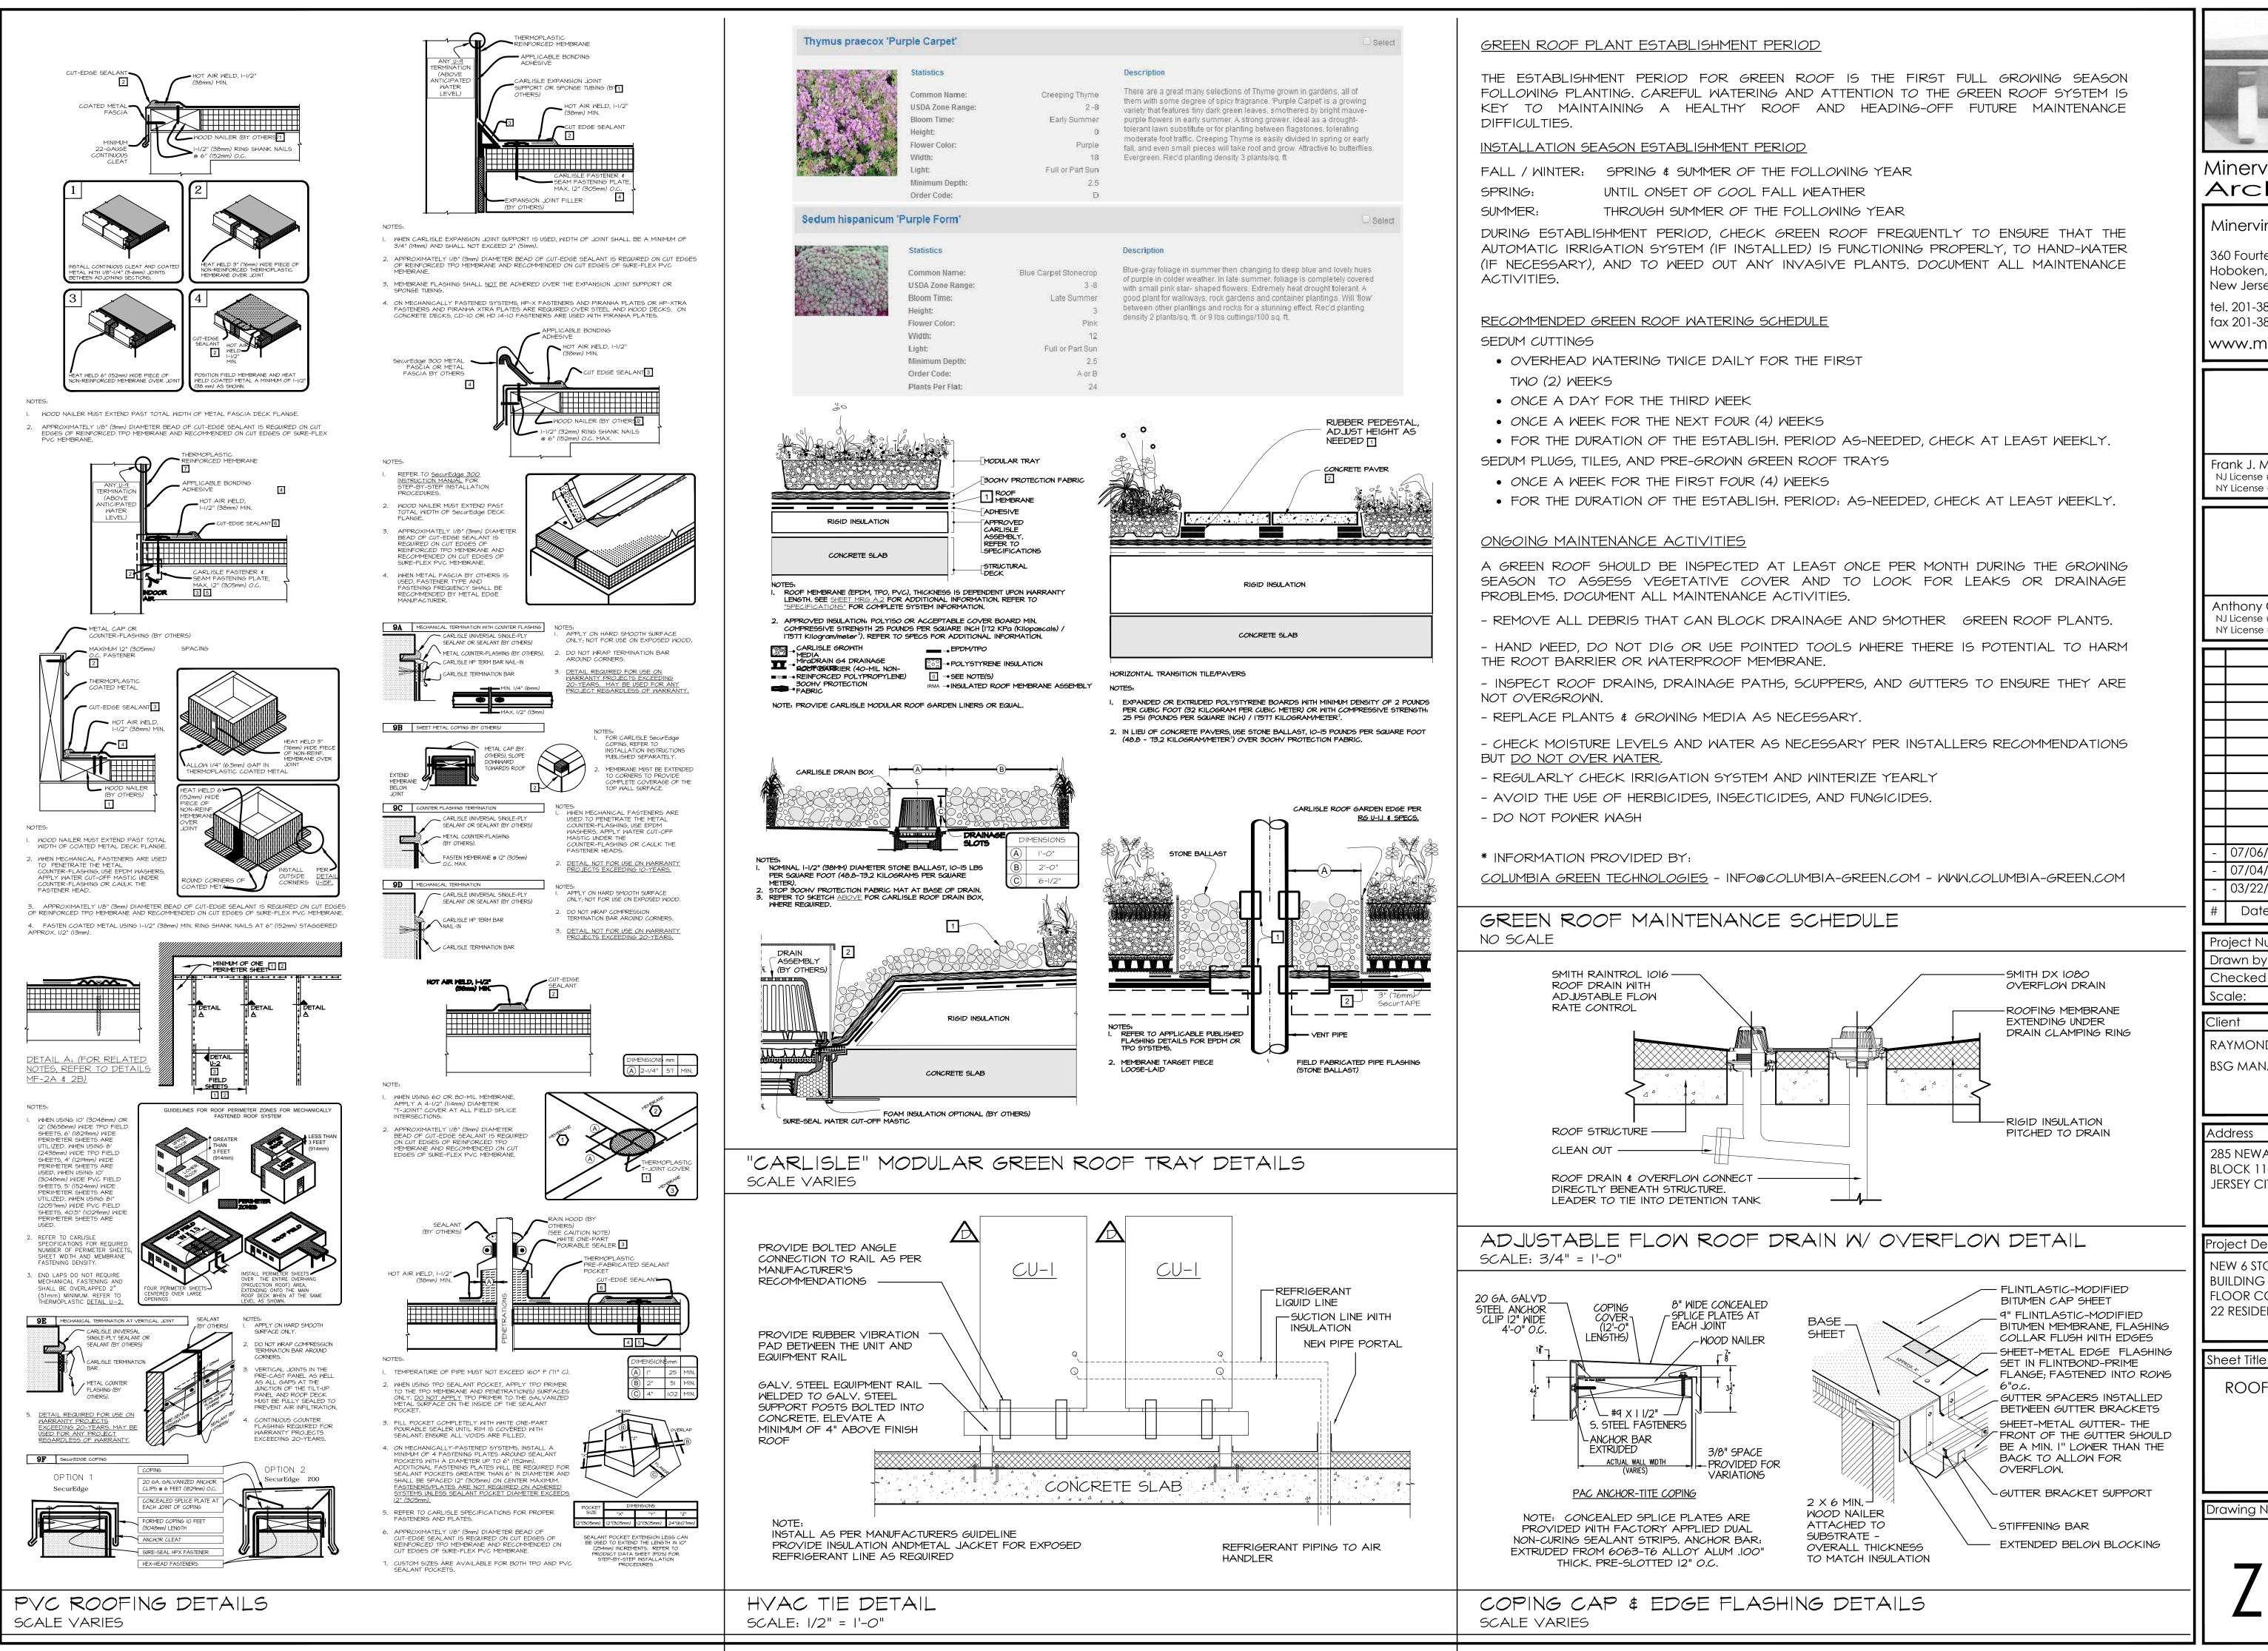


	F				
	Minervini Vandermark Architecture				
	Minervini Vandermark, LLC 360 Fourteenth St. Hoboken, New Jersey, 07030 tel. 201-386-0637 fax 201-386-0628 www.mvarchitecture.com				
	Frank J. Minervini, AIA NJ License # 12576 NY License # 03 0297 63				
	Anthony C. Vandermark, Jr. AIA NJ License # 17698 NY License # 32710-1				
	- 07/06/17 ZONING SET VNA - 07/04/17 ZONING SET				
_	-03/22/17CLIENT REVIEW#DateRevisionProject Number :17-1351Drawn by:MSChecked by:FJM, ACVScale::As noted				
	Client RAYMOND ESHAGHOFF BSG MANAGEMENT COMPANY				
_	Address 285 NEWARK AVENUE BLOCK 11004, LOT 6 JERSEY CITY, NJ 07302 Project Description				
_	NEW 6 STORY, MIXED-USE BUILDING WITH A GROUND FLOOR COMMERCIAL UNIT, AND 22 RESIDENTIAL UNITS				
	ROOF DETAILS				
	Drawing No.				

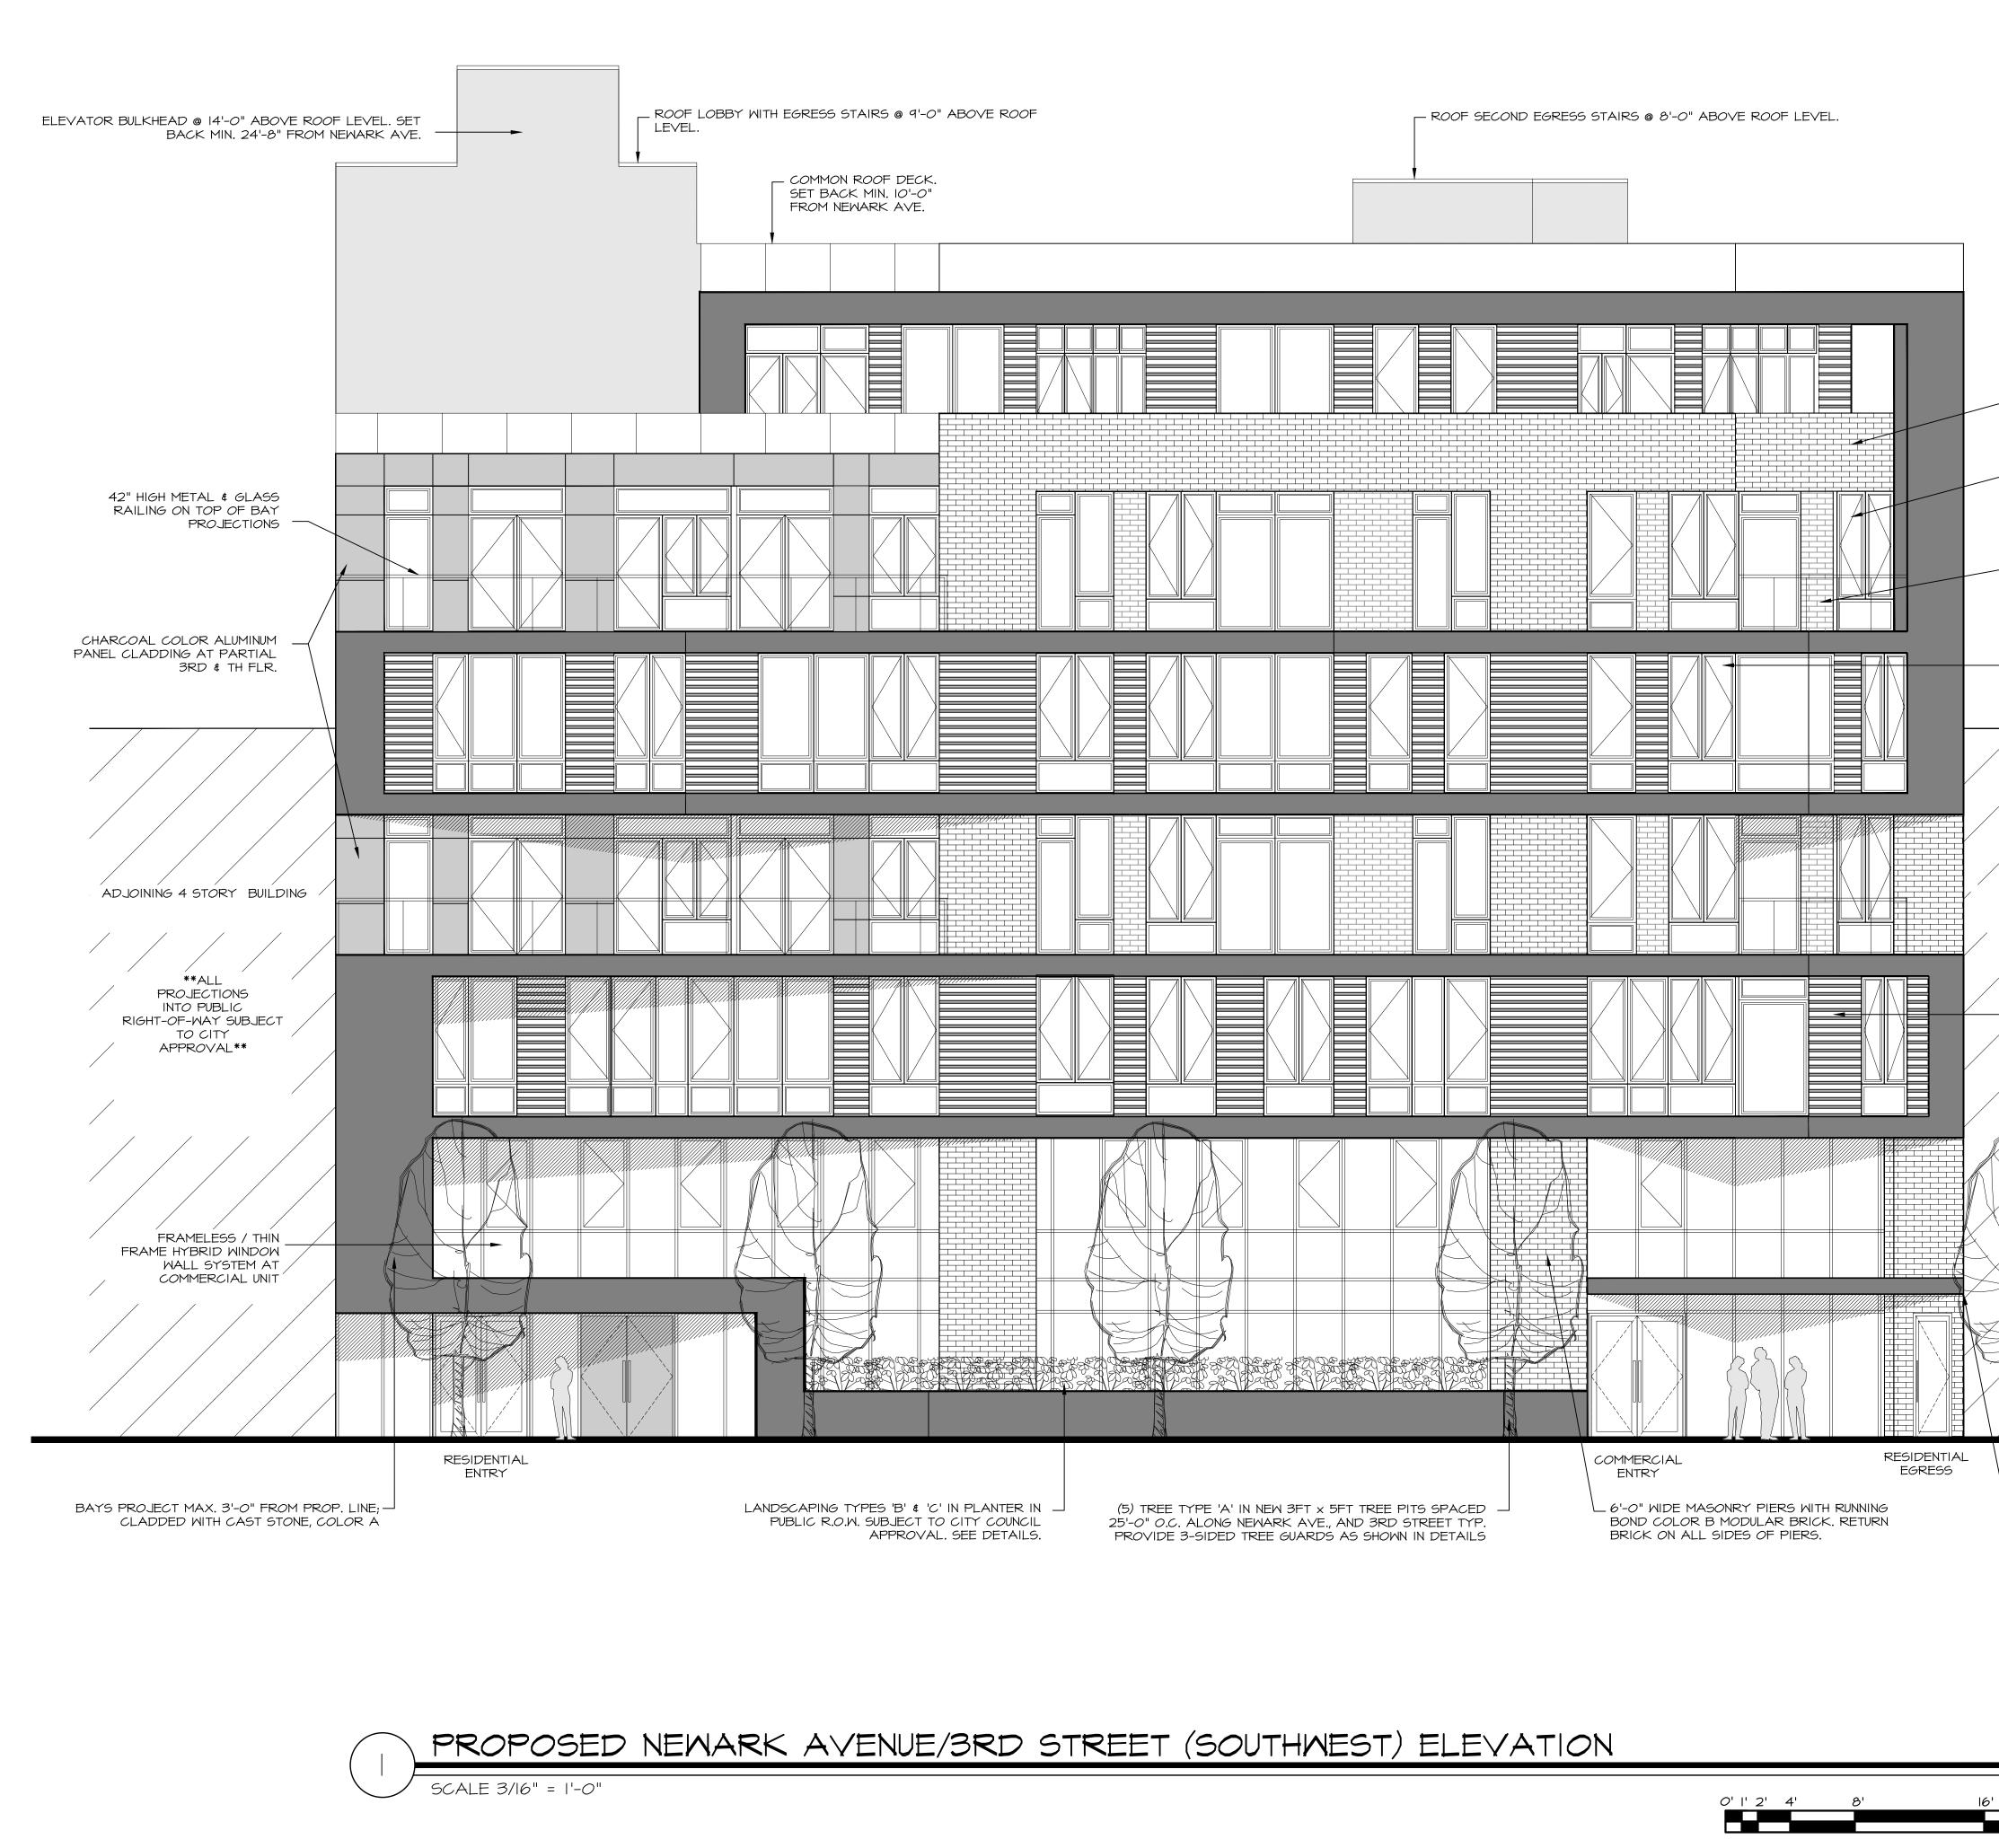


•

						F
						Minervini Vandermark Architecture Minervini Vandermark, LLC 360 Fourteenth St.
	<u>T.O. PARAPET</u>	•				360 Pouneenin 31. Hoboken, New Jersey, 07030 tel. 201-386-0637 fax 201-386-0628 www.mvarchitecture.com
MASONRY PARAPET WITH RUNNING BOND COLOR B MODULAR BRICK.			"00			
42" HIGH METAL & GLASS RAILING ON TOP OF BAY PROJECTIONS	6th FLOOR	•				Frank J. Minervini, AIA NJ License # 12576 NY License # 03 0297 63
MASONRY MID SECTION WITH RUNNING BOND COLOR C MODULAR BRICK.	5th FL <i>OO</i> R	•	"O"-O"			
		•	=0-0 -0			Anthony C. Vandermark, Jr. AlA NJ License # 17698 NY License # 32710-1
	<u>4th FLOOR</u>		~		OVERALL HEIGHT	
ADJOINING 4 STORY BUILDING	3rd FLOOR	@	"O-"O	0" HEIGHT TO SETBACK	10'-0" PROPOSED 0	- 07/06/17 ZONING SET VNA - 07/04/17 ZONING SET
BRISE SOLEIL: 2" THICK OKO SKIN SQUARE CROSS SECTION 'BAGUETTE' PIPES AT 6" O.C.			= <u>0</u> - <u>0</u>	60'-0" HEI	70	 - 03/22/17 CLIENT REVIEW # Date Revision Project Number : 17-1351 Drawn by : MS Checked by : FJM, ACV
	2nd FLOOR	—	10 0"			Scale: : As noted Client RAYMOND ESHAGHOFF BSG MANAGEMENT COMPANY
	Ist FLOOR MEZ.		10'-0"			Address 285 NEWARK AVENUE BLOCK 11004, LOT 6 JERSEY CITY, NJ 07302
	lst FLOOR +0'-0"					Project Description NEW 6 STORY, MIXED-USE BUILDING WITH A GROUND
- I'-O" TALL CAST STONE CLAD CANC EGRESS DOORS WITH OUTDOOR-RA ON UNDERSIDE (PROJECTS 36" AT M LINE)	TED RECESSED LIGHTS					FLOOR COMMERCIAL UNIT, AND 22 RESIDENTIAL UNITS Sheet Title PROPOSED ELEVATIONS: NEWARK AVE./3RD STREET
32'						Drawing No.

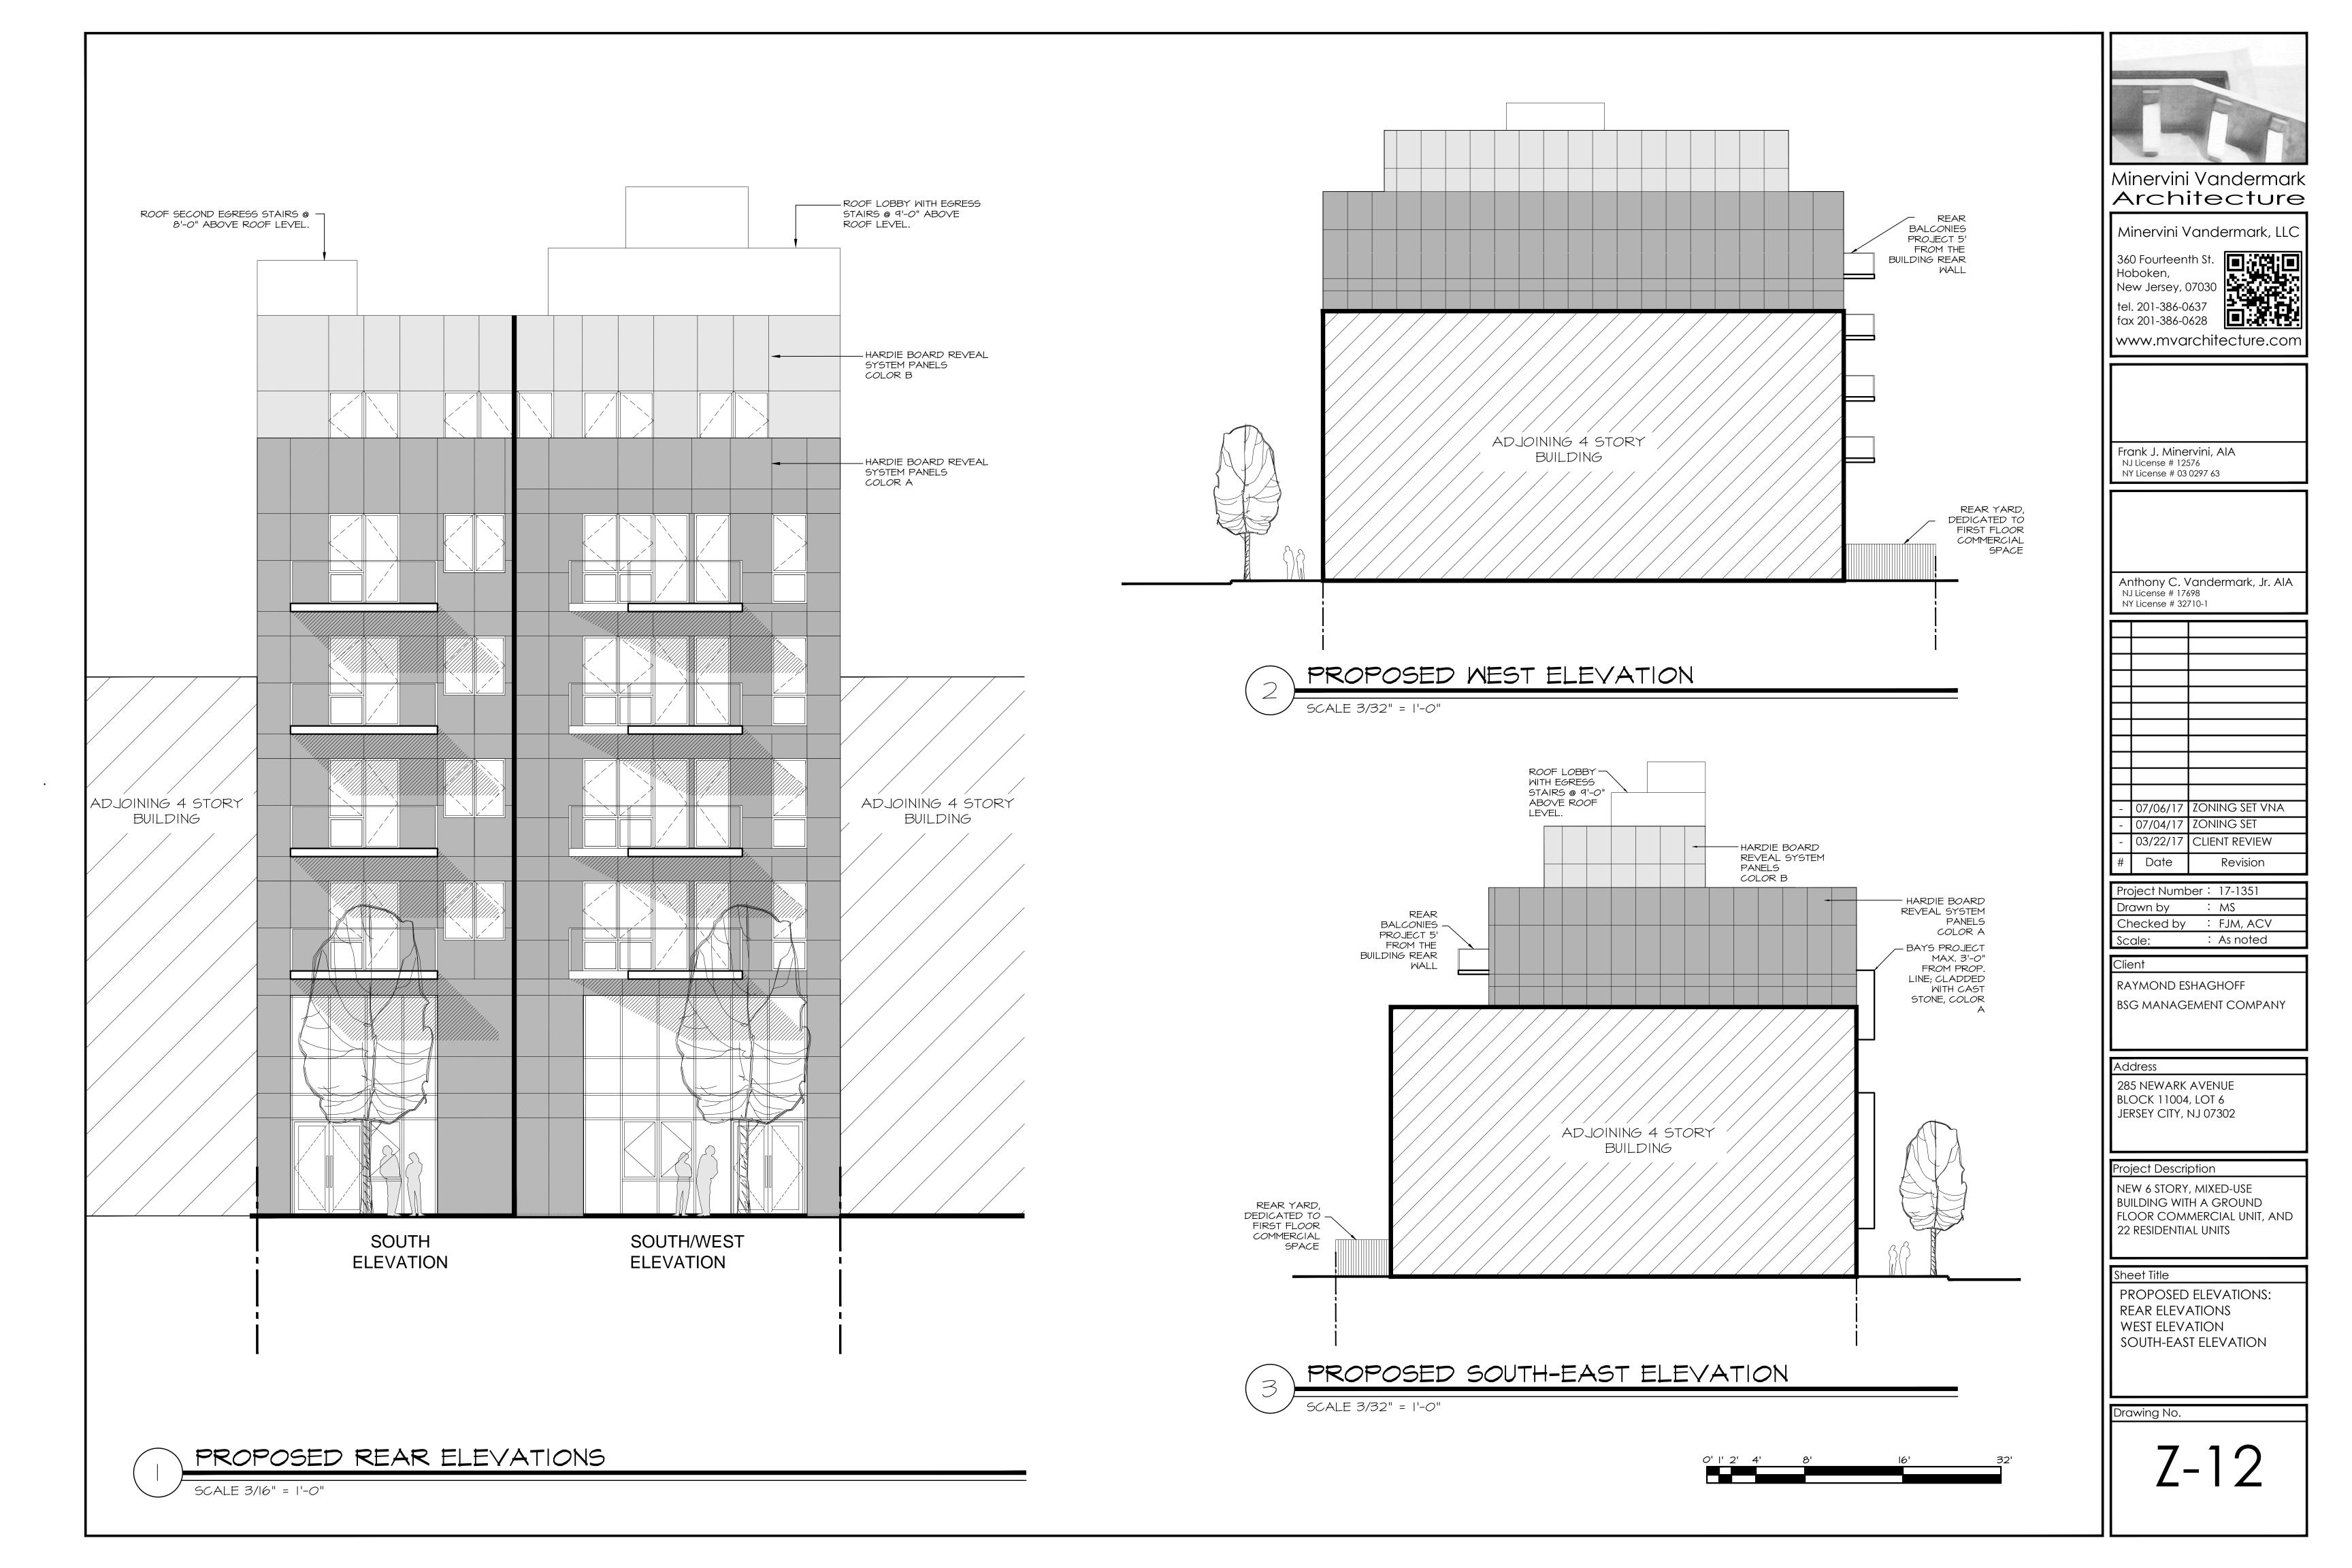






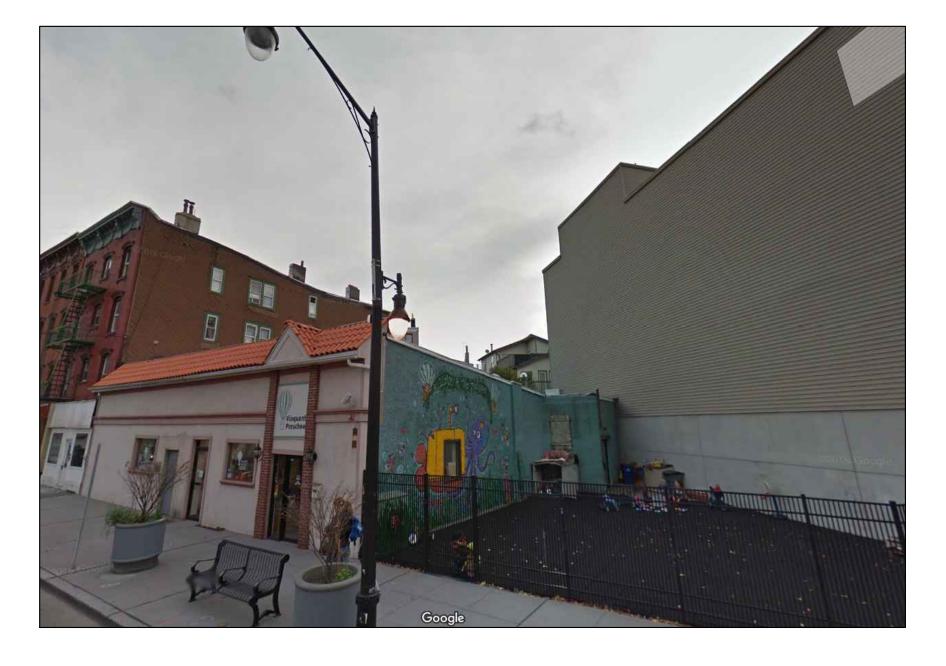






5

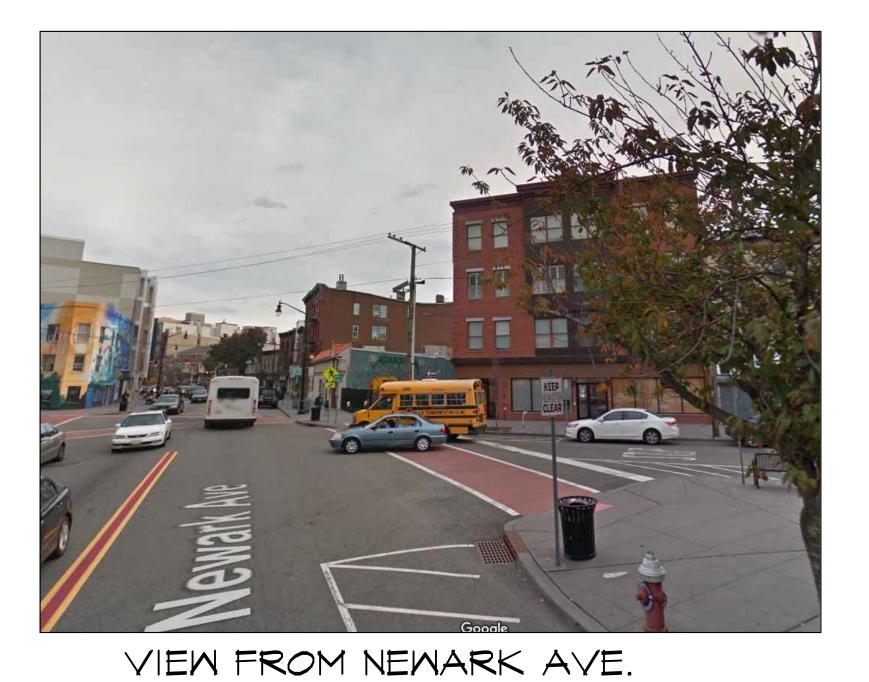

LOOKING SOUTH - EAST

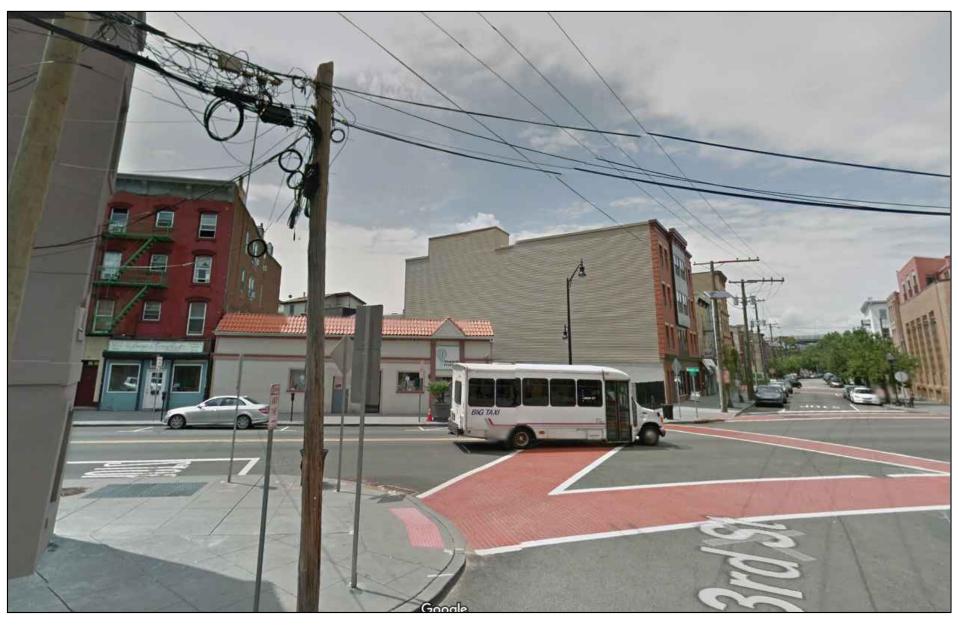

VIEW FROM C AND NEWARK N.T.S.



285 NEWARK AVE.

I.T.S.

N.T.S.





VIEW FROM CORNER OF THIRD ST. AND NEWARK AVE. LOOKING WEST

Minervini Vandermark
Architecture
Minervini Vandermark, LLC 360 Fourteenth St. Hoboken, New Jersey, 07030 tel. 201-386-0637 fax 201-386-0628 www.mvarchitecture.com
Frank J. Minervini, AIA NJ License # 12576 NY License # 03 0297 63
Anthony C. Vandermark, Jr. AIA NJ License # 17698 NY License # 32710-1
- 07/06/17 ZONING SET VNA - 07/04/17 ZONING SET - 03/22/17 CLIENT REVIEW # Date Revision
Project Number : 17-1351 Drawn by : MS Checked by : FJM, ACV Scale: : As noted Client RAYMOND ESHAGHOFF
BSG MANAGEMENT COMPANY
Address 285 NEWARK AVENUE BLOCK 11004, LOT 6 JERSEY CITY, NJ 07302
Project Description NEW 6 STORY, MIXED-USE BUILDING WITH A GROUND FLOOR COMMERCIAL UNIT, AND 22 RESIDENTIAL UNITS
Sheet Title PHOTO BOARD
Drawing No.